



US Army Corps  
of Engineers  
Alaska District

# Public Notice of Application for Permit

ANCHORAGE  
Regulatory Division (1145)  
CEPOA-RD  
Post Office Box 6898  
JBER, Alaska 99506-0898

<b>PUBLIC NOTICE DATE:</b>	<b>February 28, 2025</b>
<b>EXPIRATION DATE:</b>	<b>March 31, 2025</b>
<b>REFERENCE NUMBER:</b>	<b>POA-2024-00092</b>
<b>WATERWAY:</b>	<b>Tongass Narrows</b>

---

Interested parties are hereby notified that a Department of the Army permit application has been received for work in waters of the United States as described below and shown on the enclosed project drawings.

All comments regarding this public notice should be sent to the address noted above. If you desire to submit your comments by email, you should send it to the project manager's email as listed below or to [regpagemaster@usace.army.mil](mailto:regpagemaster@usace.army.mil). All comments should include the public notice reference number listed above.

All comments should reach this office no later than the expiration date of this public notice to become part of the record and be considered in the decision. Please contact Hayley Farrer at (907) 753-2778, toll free from within Alaska at (800) 478-2712, or by email at [Hayley.M.Farrer@usace.army.mil](mailto:Hayley.M.Farrer@usace.army.mil) if further information is desired concerning this public notice.

**APPLICANT:** Wayne Sharp, Elden Loop Development, LLC.; (206) 931-7745;  
[wayne.sharp@jw-residential.com](mailto:wayne.sharp@jw-residential.com); 10831 100<sup>th</sup> Street NE Lake Stevens, WA 98258

**AGENT:** Zach T. Huff, ABR, Inc. – Environmental Research & Services; (907) 764- 4941;  
[zhuff@abrinec.com](mailto:zhuff@abrinec.com); 1225 E. International Airport Road, Suite 110 Anchorage, AK 99518

**LOCATION:** The project site is located at Sections 31 and 6, T. 75 and 76 S., R. 91 E., Copper River Meridian; Latitude 55.31766° N., Longitude 131.65222° W.; south end of Gravina Island Highway near Ketchikan, Alaska.

**PURPOSE:** The applicant's stated purpose is to construct the infrastructure necessary to build a housing subdivision with new single-family residential home sites in the Ketchikan area. The

proposed development would be composed of eleven (11) single family homes with associated access roads, utilities, and a new boat launch and dock for the homeowners.

**PROPOSED WORK:** The applicant proposes to discharge 25,074 cubic yards of shot rock and gravel material into 2.60 acres of waters of the U.S. in order to construct eleven (11) new gravel house pads, two access roads, a community boat launch parking lot, and associated utilities for the Elden Loop Subdivision. The applicant also proposes to construct a boat launch ramp, a fixed dock, and three breakwaters in and above the mean high-water mark of the Tongass Narrows.

Specifically, the proposed project would discharge 14,181 cubic yards of shot rock and gravel material into 1.26 acres of wetlands for the construction of access roads. One 24-foot-wide by 1,980-foot-long gravel access road would extend north from the existing Gravina Highway. The roadway would be 12-foot-wide by 800-foot-long for use as a utility access trail. A turnaround area and gate would be constructed where the utility trail would start. The utility access trail would include a single 24-foot-wide by 60-foot-long bridge spanning an unnamed anadromous stream. Another 24-foot-wide by 860-foot-long gravel access road would serve the subdivision road. Two (2) 36-inch by 24-foot-long culverts would be placed and two 24-foot-wide by 60-foot-long bridges would be constructed to cross an unnamed anadromous stream. The bridges and supporting embankments would be constructed outside the stream channel and above the ordinary high-water mark (OHWM).

The house gravel pads would require placing 10,373 cubic yards of shot rock and gravel material in 1.20 acres of palustrine forested and scrub-shrub wetlands. Ten (10) new 60-foot by 60-foot gravel pads would be constructed for single family residences, including driveways and space required to install associated on-site utilities. Each gravel driveway would include a 36-inch culvert. Block 1, lot 4 would include a 24-foot by 40-foot single-span bridge crossing the unnamed stream. No fill material would be discharged below the OHWM for the single-span bridge. Block 1, lot 6 has a pre-existing single residence structure installed on pilings. A 30-foot by 50-foot driveway and 30-foot by 40-foot utility pad would be constructed to access the existing house.

A boat ramp, associated turnaround, and parking lot would be constructed near the southeast corner of the project area. For the boat launch and ramp apron 197 cubic yards of shot rock and concrete planks would be discharged into 0.068-acre of wetlands. A 39-foot-long by 29-foot-wide shot rock boat ramp apron would be constructed to transition the boat ramp to the parking lot. A 170-foot-long by 26-foot-long concrete boat ramp extending from the apron into the Tongass Narrows (-6.5 feet mean lower low water (MLLW)) would be constructed. The boat ramp would be constructed with 85 pre-cast concrete planks, each measuring at 26-feet-long by 2-feet-wide by 1-foot-deep. Site preparation to place the pre-cast planks would involve using a tracked excavator at low tide. Also, 323 cubic yards of riprap (wave attenuation boulders) would be placed into 225-feet by 16-feet area below the high tide line (0.015-acre of the Tongass Narrows (+15 MLLW to -4 feet MLLW)) parallel to the boat launch.

Six (6) existing 16-inch steel piles would be removed using a barge mounted crane with a vibratory hammer. The existing steel piles would be reused to support construction of the new

proposed floating dock facilities. A total of twelve (12) 16-inch piles would be used to support the boat launch, walkway, and dock. Piles would be installed from a construction barge using a crane-mounted vibratory hammer. Some piles would require rock sockets, which would be drilled using a large-diameter rock drill from the construction barge. A 260-foot-long by 12-foot-wide floating boat launch would be constructed parallel to the boat ramp and connect to the boat dock. A 12-foot-wide by 200-foot-long floating boat dock would be placed perpendicular to the boat launce with seven (7) designated parking bays, holding up to fourteen (14) boats total. Additional boat and seaplane parking would be available on the north side of the dock.

A 3-foot by 130-foot steel pipe double tube floating breakwater would be installed parallel to the floating boat launch. The double tube float would be anchored in placed with three (3) 25,000-pound concrete blocks. Two (2) 3-foot by 130-foot steel pipe float tube breakwaters would be installed parallel to the dock. The two (2) breakwaters would be connected with 7-feet by 12-inch diameter galvanized steel tubes. The single tube floats would be anchored using three (3) 25,000-pound concrete blocks. All three breakwaters would be used to reduce wave action and turbulence.

Construction for the subdivision would begin in April-May 2025 and anticipated to be completed in June 2025. All in water work is anticipated to begin in April 2025 and end in July 2025. Pile installation would be completed May 2025. All work would be performed in accordance with the enclosed plan (sheets 1-21), dated February 24, 2025.

**APPLICANT PROPOSED MITIGATION:** The applicant proposes the following mitigation measures to avoid, minimize, and compensate for impacts to waters of the United States from activities involving discharges of dredged or fill material.

a. Avoidance: The applicant states that given the nature of southeast Alaska and the temperate rainforest of Ketchikan, Alaska, it would be difficult to completely avoid impacting wetlands. The applicant had a wetland delineation completed in 2023, which was used to help inform engineering design. The applicant states that only 4.8 acres of the 19.0 acres delineated in the study area was comprised of uplands and complete avoidance of wetlands is not possible.

b. Minimization: The applicant states efforts were made to mitigate impacts to wetlands and waters by providing only the necessary fill to construct the access road, subdivision road, residential driveways, residential home sites, and boat launch facilities. Specific minimization measures include:

- The access road was narrowed at its second intersection with Elden Loop, as this portion of the roadway is only required to support utility construction access.
- Gravel house pads have been designed to be in uplands, when feasible.
- The gravel house pads and driveways were designed to accommodate the anticipated home footprints and utilities each home site would require (e.g. septic system).
- The proposed project would install four (4) prefabricated bridges for each of the crossings of the unnamed anadromous stream. The bridges would be installed

without piers or piles placed below the OHWM to ensure fish passage is maintained while minimizing the stream crossing's footprint.

- The proposed breakwater would be constructed by placing individual large riprap (boulders) (versus constructing a solid linear feature).
- The proposed proposes including three (3) tubular floating breakwaters to help with wave attenuation at the dock and boat launch (versus constructing additional breakwater from riprap)

c. Compensatory Mitigation: The applicant does not proposed compensation for the unavoidable impacts to wetlands. The applicant states that Ketchikan is noted for lacking available housing that is creating undo pressures on the local community and this project would expand available housing for the community. Additionally, the applicant states that the wetlands found in the project area are quite common within the watershed and efforts have been made to minimize impacts to them.

**WATER QUALITY CERTIFICATION:** A permit for the described work will not be issued until a certification or waiver of certification, as required under Section 401 of the Clean Water Act (Public Law 95-217), has been received from the Alaska Department of Environmental Conservation.

**CULTURAL RESOURCES:** The latest published version of the Alaska Heritage Resources Survey (AHRS) has been consulted for the presence or absence of historic properties, including those listed in or eligible for inclusion in the National Register of Historic Places. There are cultural resources within the vicinity of the permit area. The permit area has been determined to be the footprint of the proposed project including immediate upland locations where construction equipment would be staged. Consultation of the AHRS constitutes the extent of cultural resource investigations by the Corps of Engineers (Corps) at this time. This application is being coordinated with the State Historic Preservation Office (SHPO), federally recognized tribes, and other consulting parties. Any comments SHPO, federally recognized tribes, and other consulting parties may have concerning presently unknown archeological or historic data that may be lost or destroyed by work under the requested permit will be considered in our final assessment of the described work. The Corps is requesting the SHPO's comments regarding potential effects to historic resources within the vicinity of the permit area.

**ENDANGERED SPECIES:** The project area is within the known or historic range of the fin whale (*Balaenoptera physalus*), the Mexico Distinct Population Segment (DPS) humpback whale (*Megaptera novaeangliae*), and the sunflower sea star (*Pycnopodia helianthoides*).

We have determined the described activity may affect but is not likely to adversely affect the endangered fin whale, the threatened Mexico DPS humpback, and the proposed to be listed as threatened sunflower sea star. We will initiate the appropriate consultation procedures under section 7 of the Endangered Species Act with the National Marine Fisheries Service (NMFS). Any comments they may have concerning endangered or threatened wildlife or plants or their critical habitat will be considered in our final assessment of the described work.

**ESSENTIAL FISH HABITAT:** The Magnuson-Stevens Fishery Conservation and Management Act (Magnuson-Stevens Act), as amended by the Sustainable Fisheries Act of 1996, requires all Federal agencies to consult with the NMFS on all actions, or proposed actions, permitted, funded, or undertaken by the agency, that may adversely affect Essential Fish Habitat (EFH).

The project area is within mapped EFH for pink salmon (*Oncorhynchus gorbuscha*), Chinook salmon (*O. tshawytscha*), sockeye salmon (*O. nerka*), chum salmon (*O. keta*), and coho salmon (*O. kisutch*).

We are currently gathering information regarding these species and have yet to make a determination of effect. Should we find that the described activity may adversely affect EFH for the species listed above, we will follow the appropriate course of action under Section 305(b)(2) of the Magnuson-Stevens Act. Any comments the NMFS may have concerning EFH will be considered in our final assessment of the described work.

**TRIBAL CONSULTATION:** The Corps fully supports tribal self-governance and government-to-government relations between Federally recognized Tribes and the Federal government. Tribes with protected rights or resources that could be significantly affected by a proposed Federal action (e.g., a permit decision) have the right to consult with the Corps, Alaska District, on a government-to-government basis. Views of each Tribe regarding protected rights and resources will be accorded due consideration in this process. This public notice serves as notification to the Tribes within the area potentially affected by the proposed work and invites their participation in the Federal decision-making process regarding the protected Tribal rights or resources. Consultation may be initiated by the affected Tribe upon written request to the District Commander. This application is being coordinated with federally recognized tribes and other consulting parties. Any comments federal recognized tribes and other consulting parties may have concerning presently unknown archeological or historic data that may be lost or destroyed by the work under the requested permit will be considered in the Corps final assessment of the described work.

**PUBLIC HEARING:** Any person may request, in writing, within the comment period specified in this notice, that a public hearing be held to consider this application. Requests for public hearings shall state, with particularity, reasons for holding a public hearing.

**EVALUATION:** The decision whether to issue a permit will be based on an evaluation of the probable impacts, including cumulative impacts of the proposed activity and its intended use on the public interest. Evaluation of the probable impacts, which the proposed activity may have on the public interest, requires a careful weighing of all the factors that become relevant in each particular case. The benefits, which reasonably may be expected to accrue from the proposal, must be balanced against its reasonably foreseeable detriments. The outcome of the general balancing process would determine whether to authorize a proposal, and if so, the conditions under which it will be allowed to occur. The decision should reflect the national concern for both protection and utilization of important resources. All factors, which may be relevant to the proposal, must be considered including the cumulative effects thereof. Among those are conservation, economics, aesthetics, general environmental concerns, wetlands, cultural values, fish and wildlife values, flood hazards, floodplain values, land use, navigation,

shore erosion and accretion, recreation, water supply and conservation, water quality, energy needs, safety, food and fiber production, mineral needs, considerations of property ownership, and, in general, the needs and welfare of the people. For activities involving 404 discharges, a permit will be denied if the discharge that would be authorized by such permit would not comply with the Environmental Protection Agency's 404(b)(1) guidelines. Subject to the preceding sentence and any other applicable guidelines or criteria (see Sections 320.2 and 320.3), a permit will be granted unless the District Commander determines that it would be contrary to the public interest.

The Corps is soliciting comments from the public; Federal, State, and local agencies and officials; Indian Tribes; and other interested parties in order to consider and evaluate the impacts of this proposed activity. Any comments received will be considered by the Corps to determine whether to issue, modify, condition, or deny a permit for this proposal. To make this decision, comments are used to assess impacts on endangered species, historic properties, water quality, general environmental effects, and the other public interest factors listed above. Comments are used in the preparation of an Environmental Assessment and/or an Environmental Impact Statement pursuant to the National Environmental Policy Act. Comments are also used to determine the need for a public hearing and to determine the overall public interest of the proposed activity.

AUTHORITY: This permit will be issued or denied under the following authorities:

- (X) Perform work in or affecting navigable waters of the United States – Section 10 Rivers and Harbors Act 1899 (33 U.S.C. 403).
- (X) Discharge dredged or fill material into waters of the United States – Section 404 Clean Water Act (33 U.S.C. 1344). Therefore, our public interest review will consider the guidelines set forth under Section 404(b) of the Clean Water Act (40 CFR 230).

Project drawings are enclosed with this public notice.

District Commander  
U.S. Army, Corps of Engineers

Enclosures



Study Area

Anadromous Stream<sup>1</sup>

0 500 1,000 1,500 2,000  
Feet

0 250 500 750  
Meters



**Map 1,  
POA-2024-00092,  
Tongass Narrows  
Location and Vicinity Map,  
Elden Loop Subdivision.**

map prepared by:  
— Environmental Research & Services  
Map1\_Gravinalisland\_SA\_Corps\_23-129.mxd; 27 January 2025

POA-2024-00092

Sheet 1 of 21

February 24, 2025



### NWI Code<sup>1</sup> NWI Description

#### Waters


- E1UBL Estuarine Subtidal Unconsolidated Bottom
- E2RSN Estuarine Intertidal Regularly Flooded Rocky Shore
- R3UBH Riverine Upper Perennial Permanently Flooded Unconsolidated Bottom

#### Wetlands


- PSS4/EM1D Palustrine Continuously Saturated Needle-leaved Evergreen Shrub/Persistent Emergent Scrub
- PFO4B Palustrine Seasonally Saturated Needle-leaved Evergreen Forest

#### Uplands

- U Upland
- Us Upland (fill)

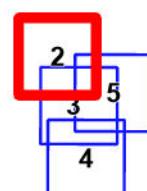

0 50 100 150 Feet  
0 10 20 30 40 50 Meters

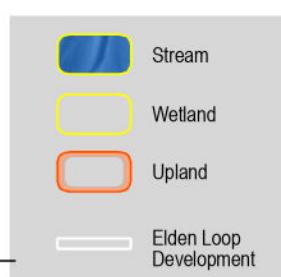

**Map 2**  
**POA-2024-00092**  
**Tongass Narrows**  
**Wetlands and Waters Impacts**  
**Elden Loop Subdivision.**

 map prepared by:  
Environmental Research & Services

Maps2-5\_Gravina\_Island\_Wetlands\_Corps\_23-129.mxd; 27 January 2025

<sup>1</sup> National Wetland Inventory (NWI) nomenclature based on FGDC 2013.



### NWI Code<sup>1</sup> NWI Description

#### Waters


- E1UBL Estuarine Subtidal Unconsolidated Bottom
- E2RSN Estuarine Intertidal Regularly Flooded Rocky Shore
- R3UBH Riverine Upper Perennial Permanently Flooded Unconsolidated Bottom

#### Wetlands


- PSS4/EM1D Palustrine Continuously Saturated Needle-leaved Evergreen Shrub/Persistent Emergent Scrub
- PFO4B Palustrine Seasonally Saturated Needle-leaved Evergreen Forest

#### Uplands

- U Upland
- Us Upland (fill)

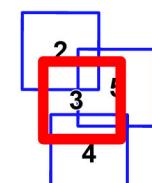

0 50 100 150 Feet  
0 10 20 30 40 50 Meters

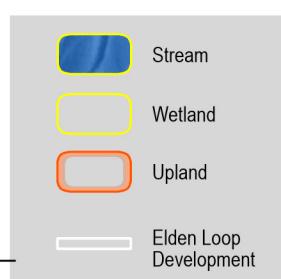

**Map 3**  
**POA-2024-00092**  
**Tongass Narrows**  
**Wetlands and Waters Impacts**  
**Elden Loop Subdivision.**

 map prepared by:  
Environmental Research & Services

Maps2-5\_Gravina\_Island\_Wetlands\_Corps\_23-129.mxd; 14 February 2025

<sup>1</sup> National Wetland Inventory (NWI) nomenclature based on FGDC 2013.



## NWI Code<sup>1</sup> NWI Description

### Waters


- E1UBL Estuarine Subtidal Unconsolidated Bottom
- E2RSN Estuarine Intertidal Regularly Flooded Rocky Shore
- R3UBH Riverine Upper Perennial Permanently Flooded Unconsolidated Bottom

### Wetlands


- PSS4/EM1D Palustrine Continuously Saturated Needle-leaved Evergreen Shrub/Persistent Emergent Scrub
- PFO4B Palustrine Seasonally Saturated Needle-leaved Evergreen Forest

### Uplands

- U Upland
- Us Upland (fill)

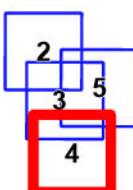

0 50 100 150 Feet  
0 10 20 30 40 50 Meters

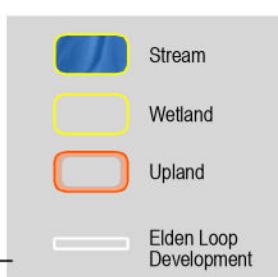

**Map 4**  
**POA-2024-00092**  
**Tongass Narrows**  
**Wetlands and Waters Impacts**  
**Elden Loop Subdivision.**



map prepared by:  
— Environmental Research & Services

Maps2-5\_Gravina\_Island\_Wetlands\_Corps\_23-129.mxd; 27 January 2025

<sup>1</sup> National Wetland Inventory (NWI) nomenclature based on FGDC 2013.



### NWI Code<sup>1</sup> NWI Description

#### Waters


- E1UBL Estuarine Subtidal Unconsolidated Bottom
- E2RSN Estuarine Intertidal Regularly Flooded Rocky Shore
- R3UBH Riverine Upper Perennial Permanently Flooded Unconsolidated Bottom

#### Wetlands


- PSS4/EM1D Palustrine Continuously Saturated Needle-leaved Evergreen Shrub/Persistent Emergent Scrub
- PFO4B Palustrine Seasonally Saturated Needle-leaved Evergreen Forest

#### Uplands


- U Upland
- Us Upland (fill)


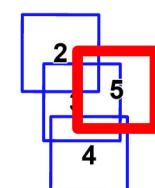


0 50 100 150 Feet  
0 10 20 30 40 50 Meters

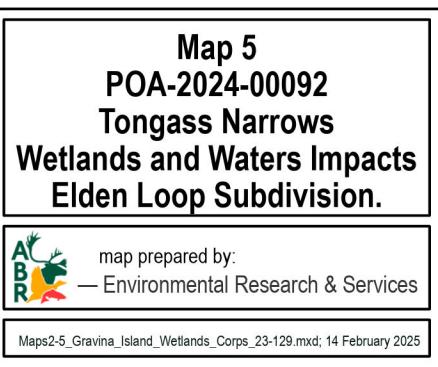

<sup>1</sup> National Wetland Inventory (NWI) nomenclature based on FGDC 2013.

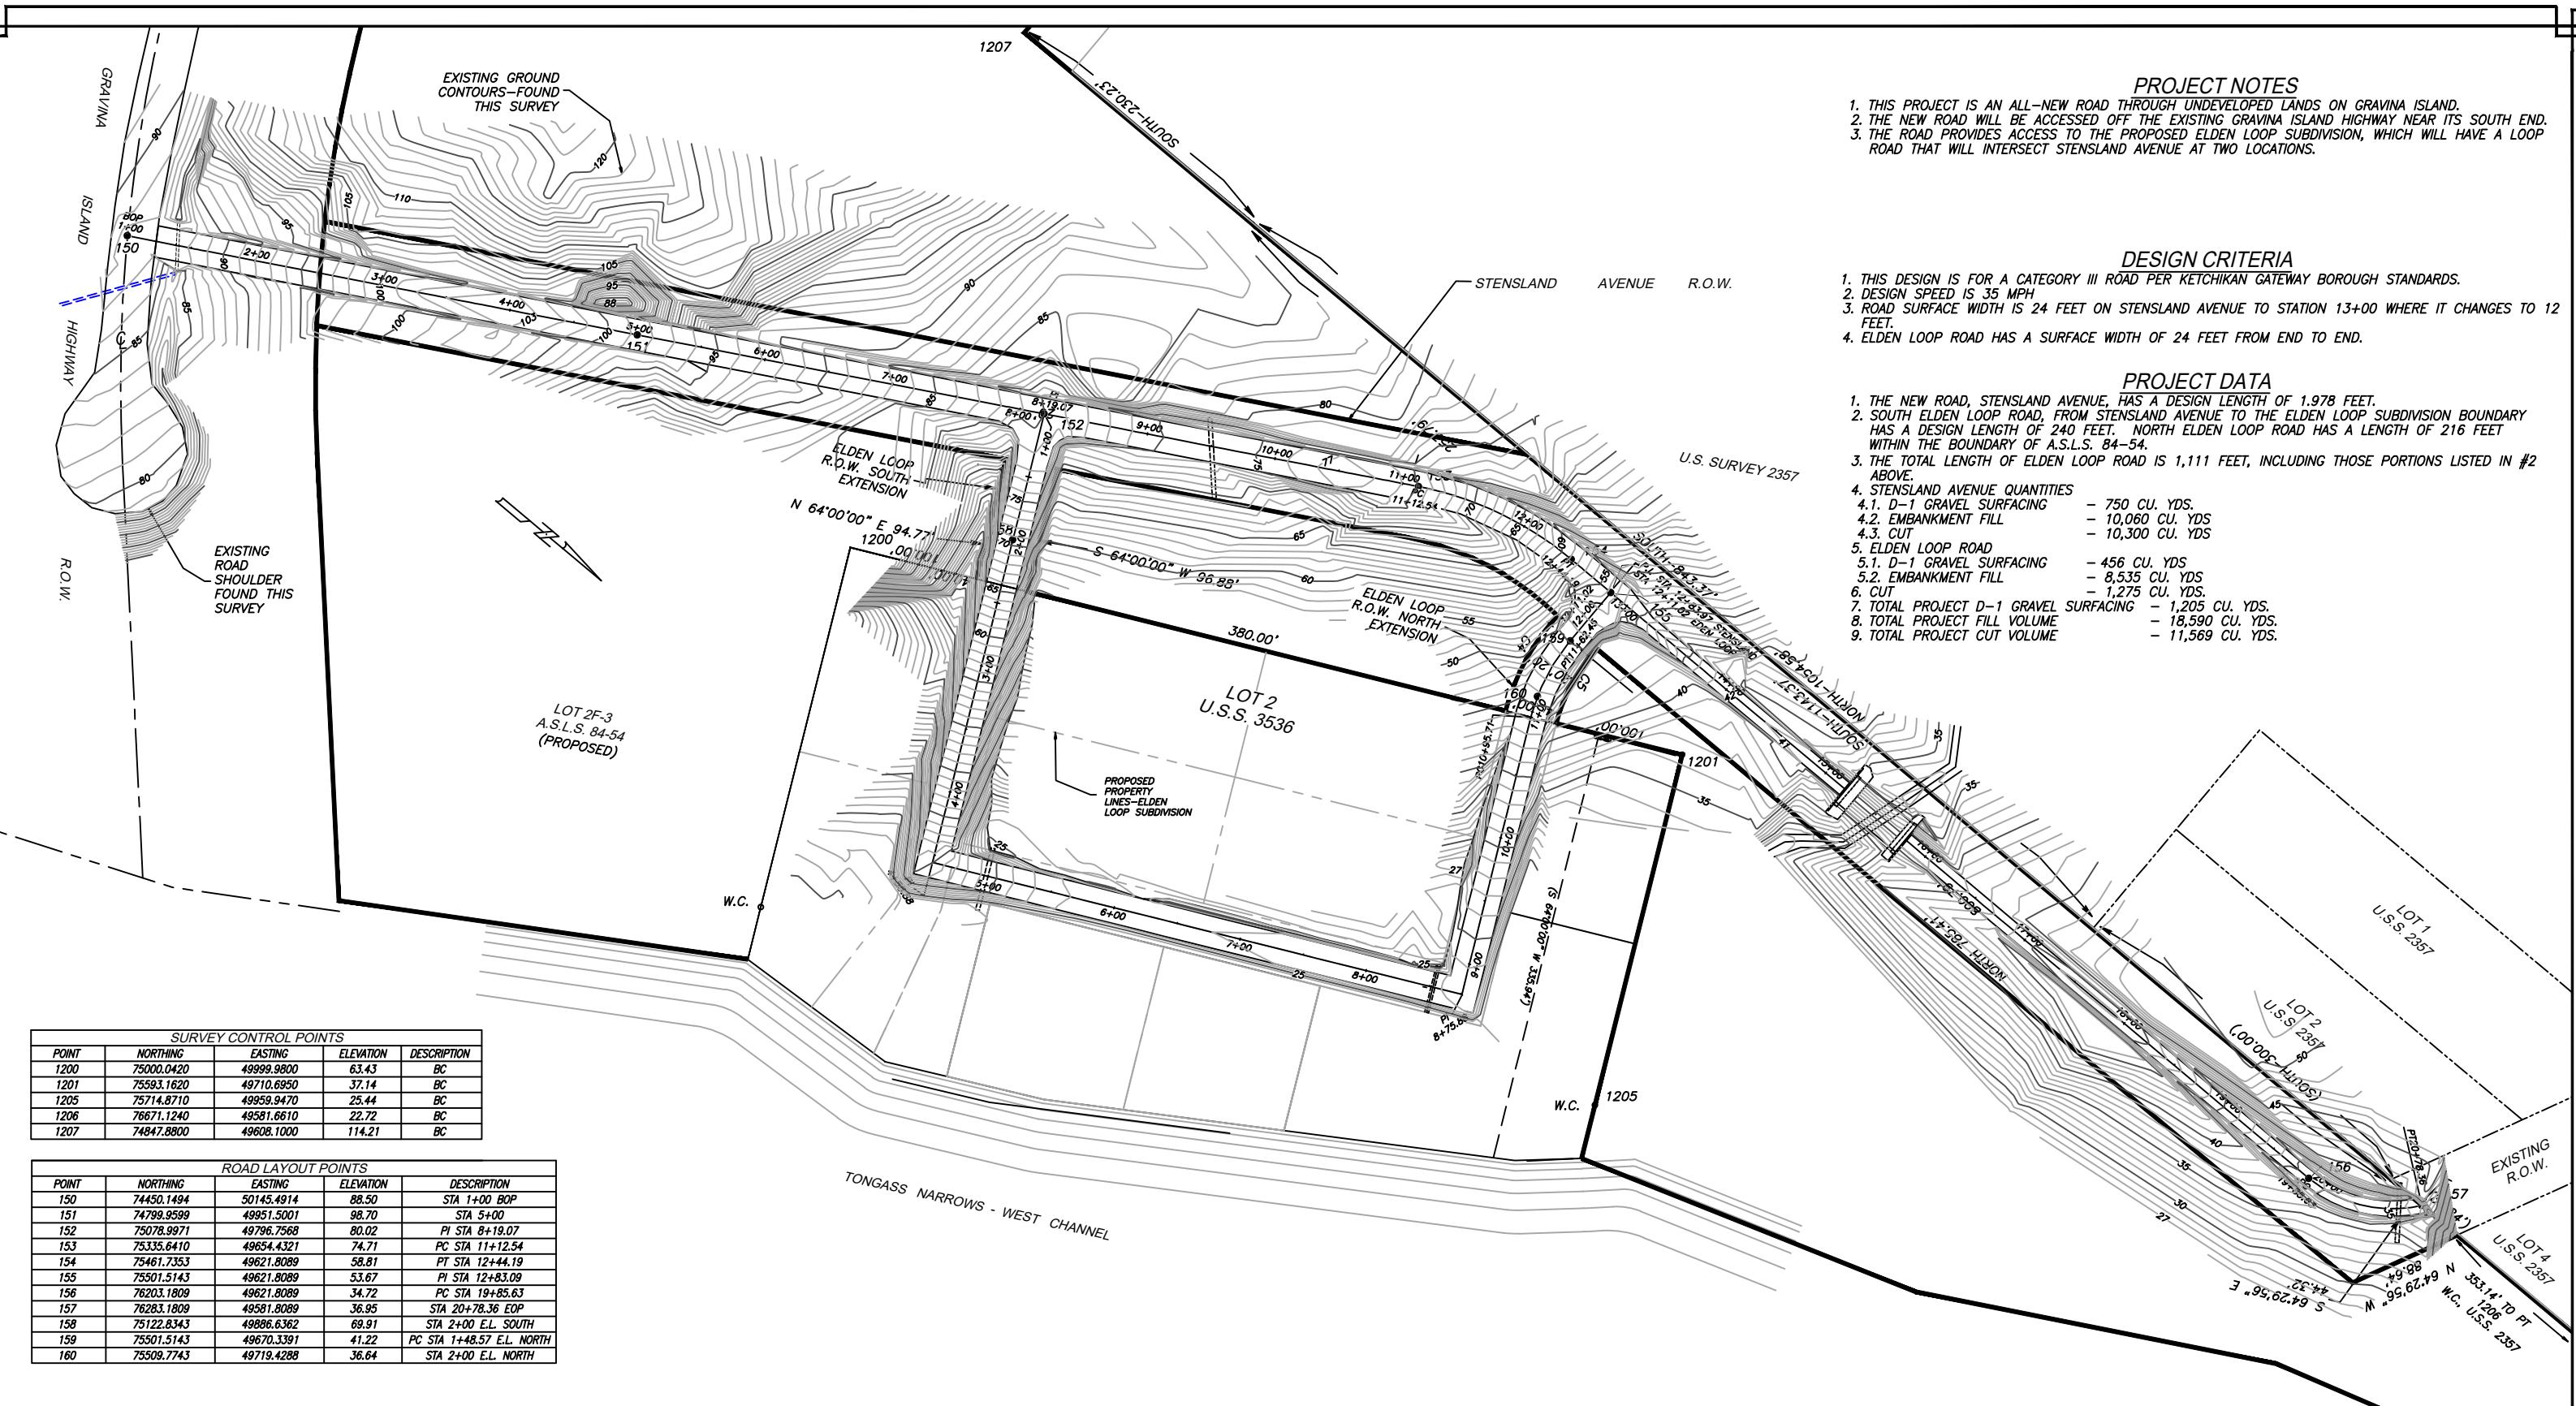

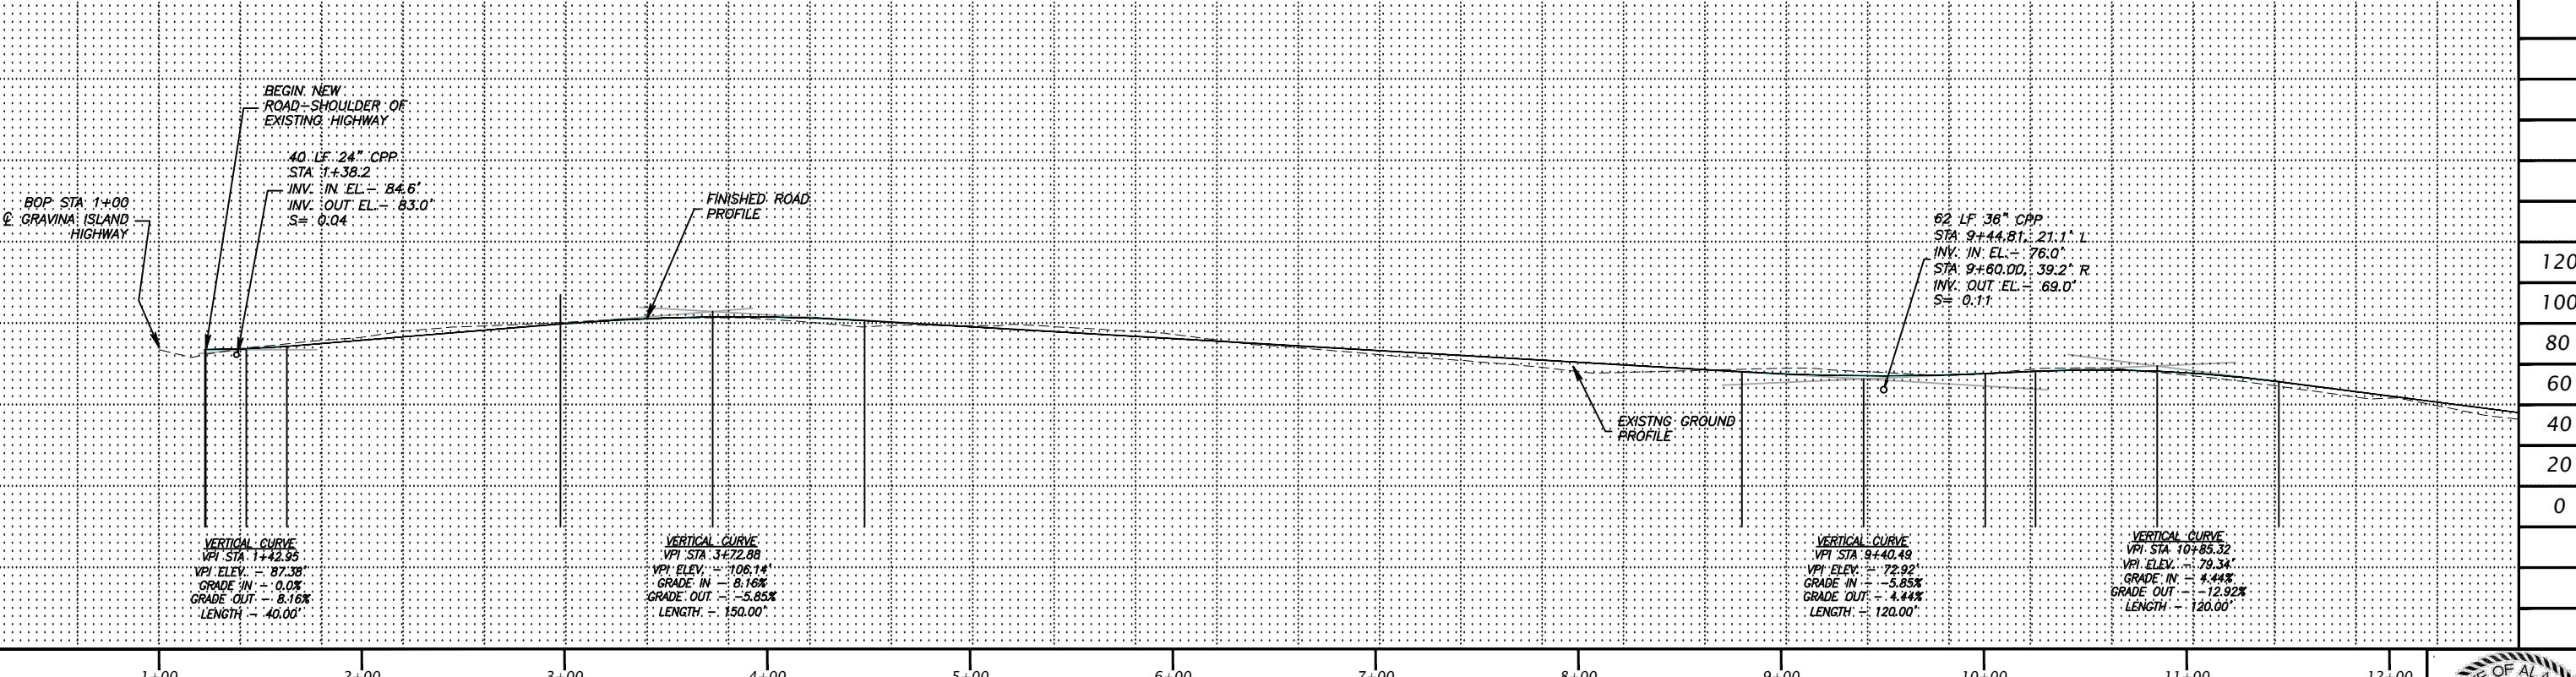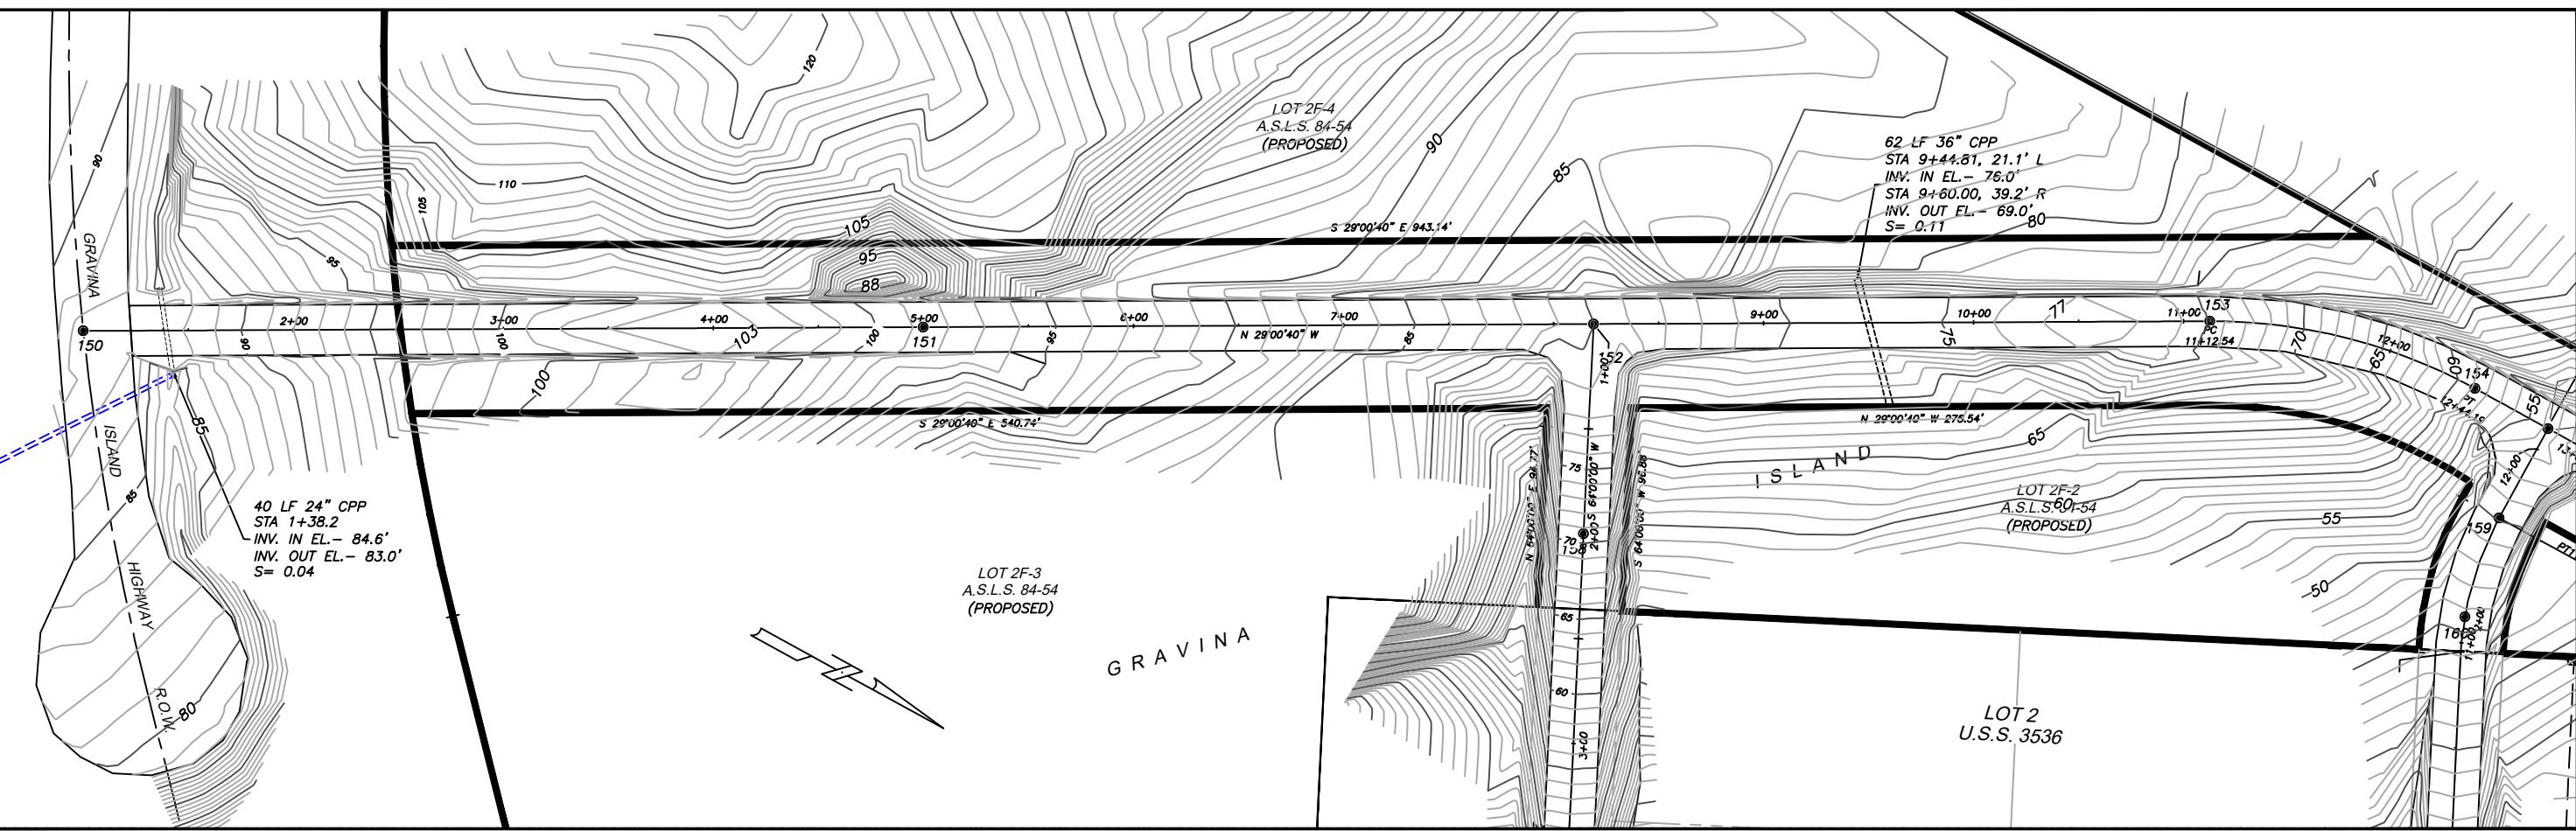

MENZIES ENGINEERING GROUP, INC.  
9737 MUD BAY ROAD, SUITE 301  
KETCHIKAN, ALASKA 99901


PH: (907)-220-9424  
FAX: (907)-220-9425  
EMAIL: SCOT@MEGALASKA.COM


CLIENT:  
CLAM COVE HOLDINGS, LLC

PROJECT:  
STENSLAND AVENUE DESIGN  
KETCHIKAN, ALASKA

SHEET DESCRIPTION:  
ROAD PLAN AND PROFILE  
STA 1+00 - X+XX

DATE NO.	DESCRIPTION	REVISIONS	BY	CHECKED: SAM	PROJECT NO.	23701
				DRAWN: SAM	DESIGNED: SAM	APPROVED: SAM

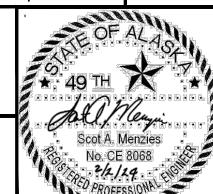

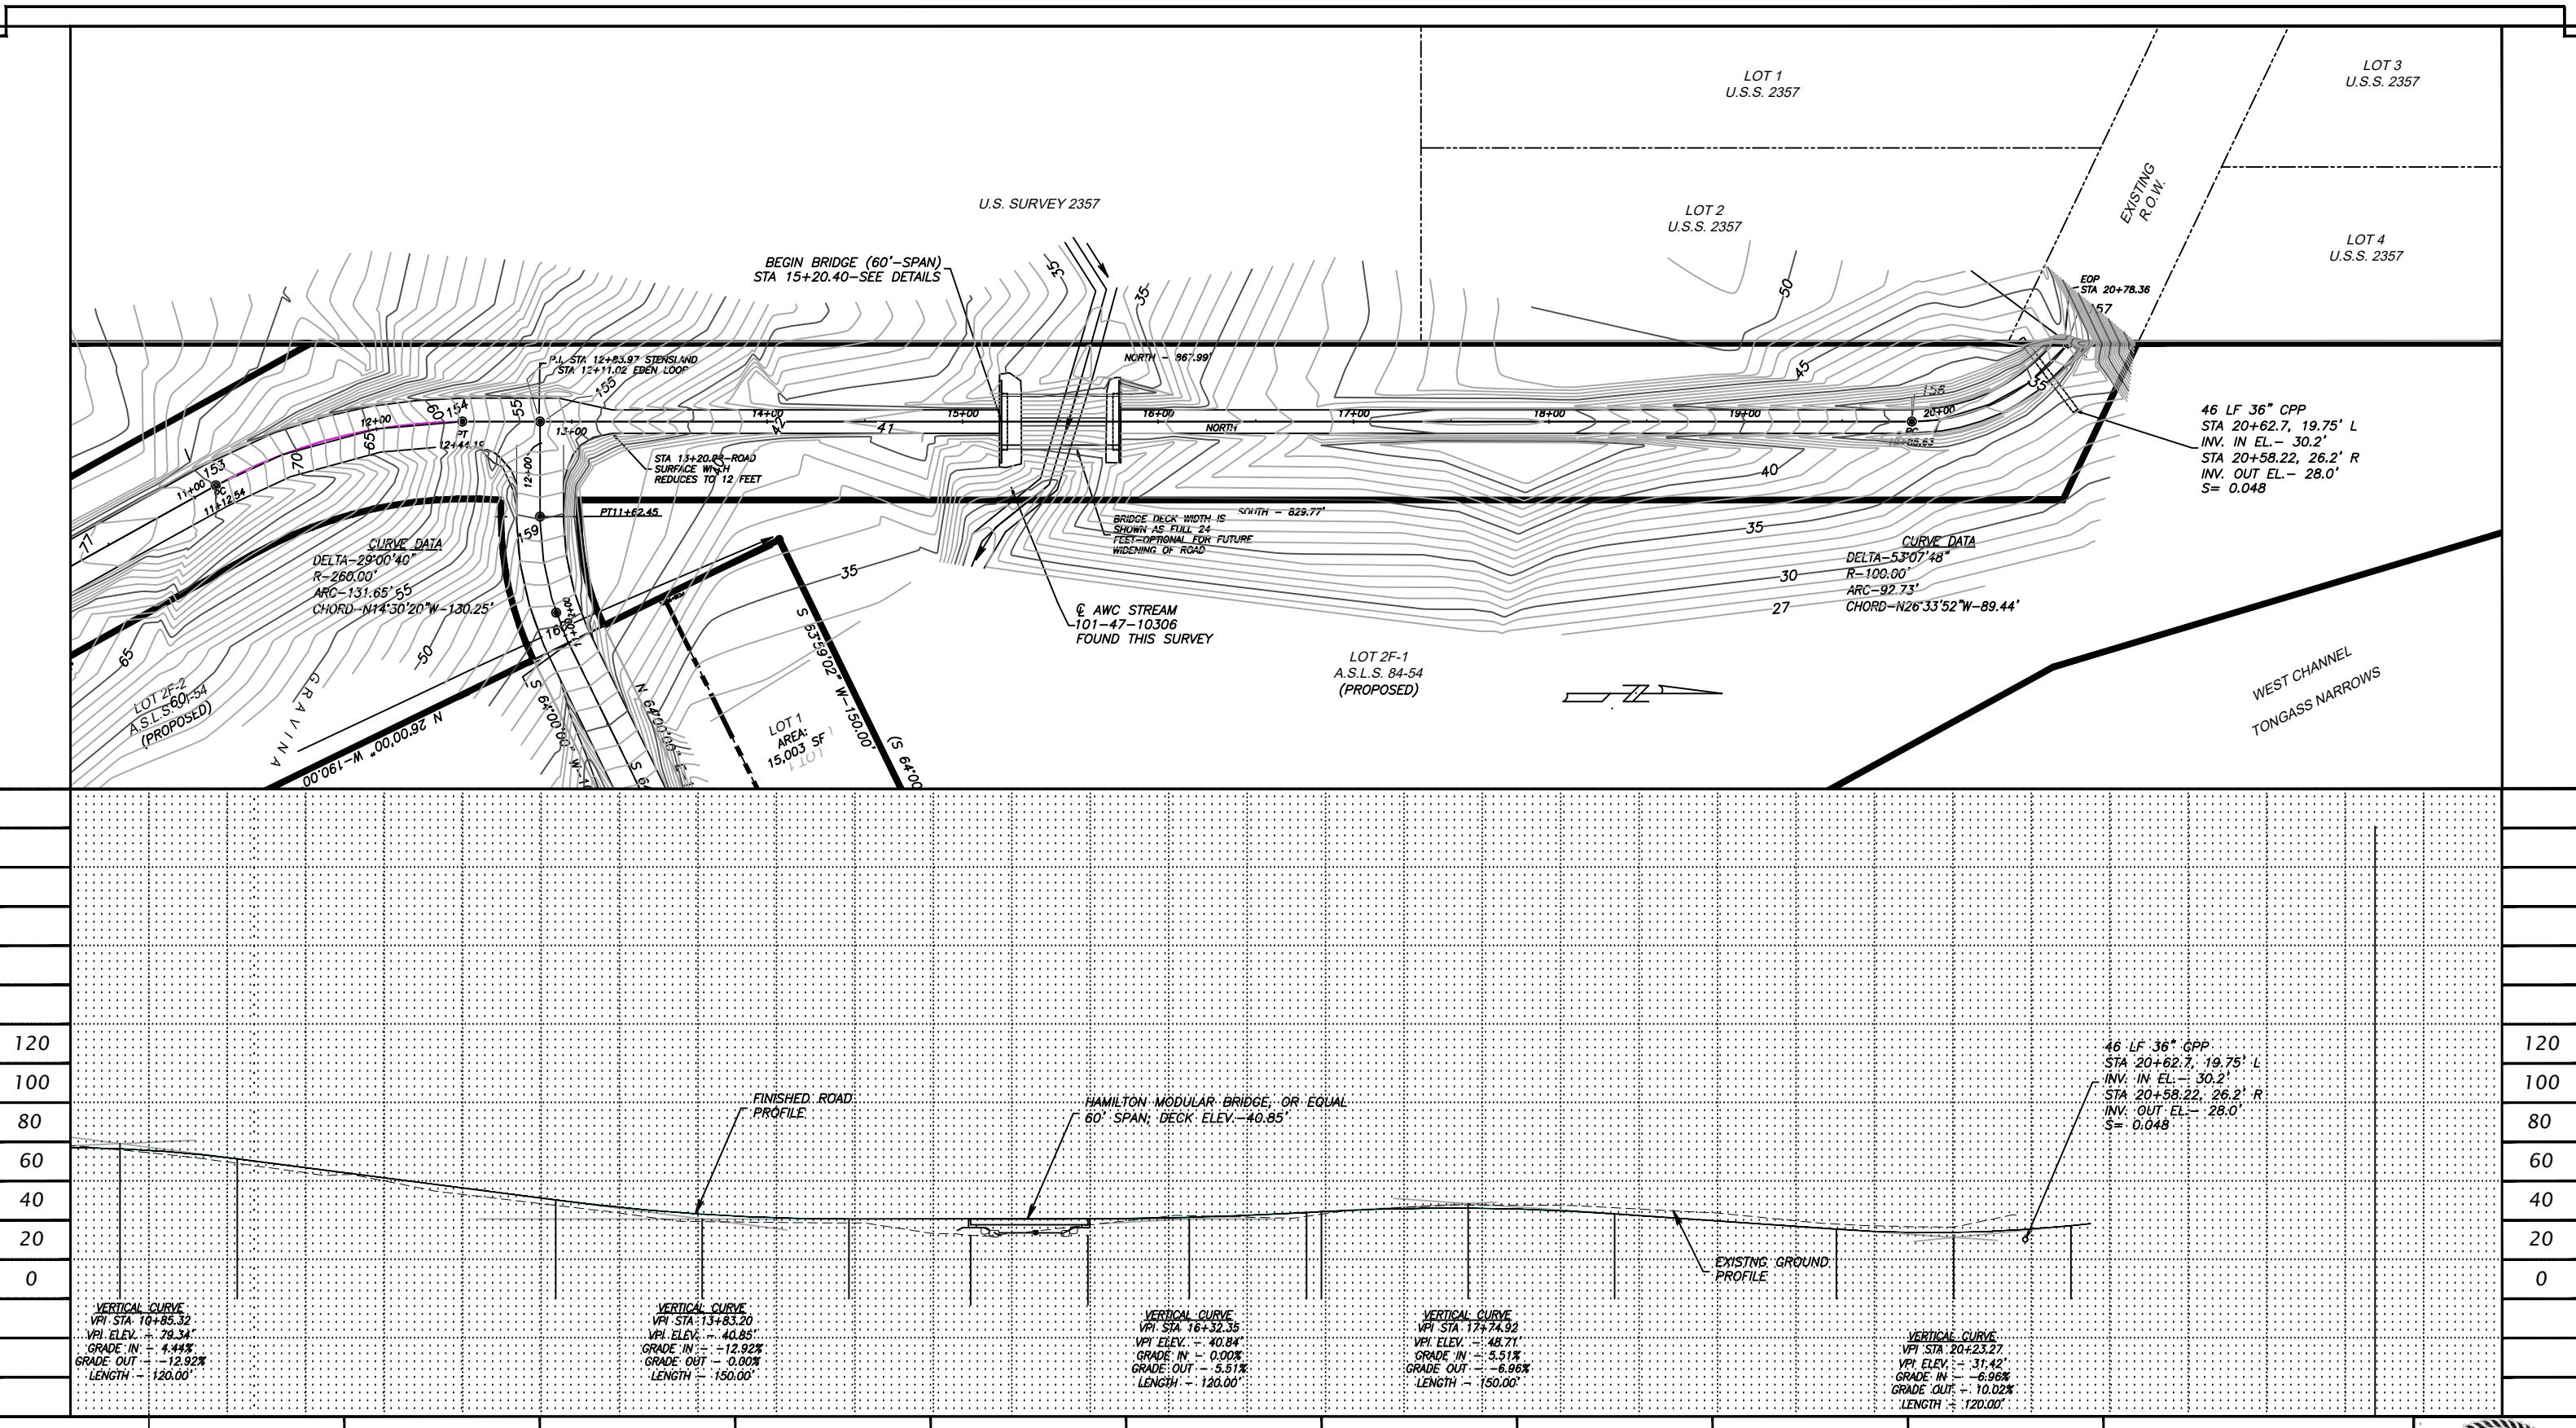

MENZIES ENGINEERING GROUP, INC.  
9737 MUD BAY ROAD, SUITE 301  
KETCHIKAN, ALASKA 99901

PH: (907)-220-9424  
FAX: (907)-220-9425  
EMAIL: SCOT@MEGALASKA.COM

CLIENT:

CLAM COVE HOLDINGS, LLC

PROJECT:

STENSLAND AVENUE DESIGN  
KETCHIKAN, ALASKA

SHEET DESCRIPTION:  
ROAD PLAN AND PROFILE  
STA 1+00 - X+XX

DATE NO.	DESCRIPTION	REVISIONS	BY	CHECKED: SAM	PROJECT NO. 23701	DESIGNED: SAM	APPROVED: SAM	SHEET NO. 3.0
						DRAWN: SAM	SCALE: 1" = 40'	DATE: 2/2/2024




Scot A. Menzies  
No. CE 8068  
REGISTERED PROFESSIONAL ENGINEER

POA-2024-00092

Sheet 8 of 21

February 24, 2025

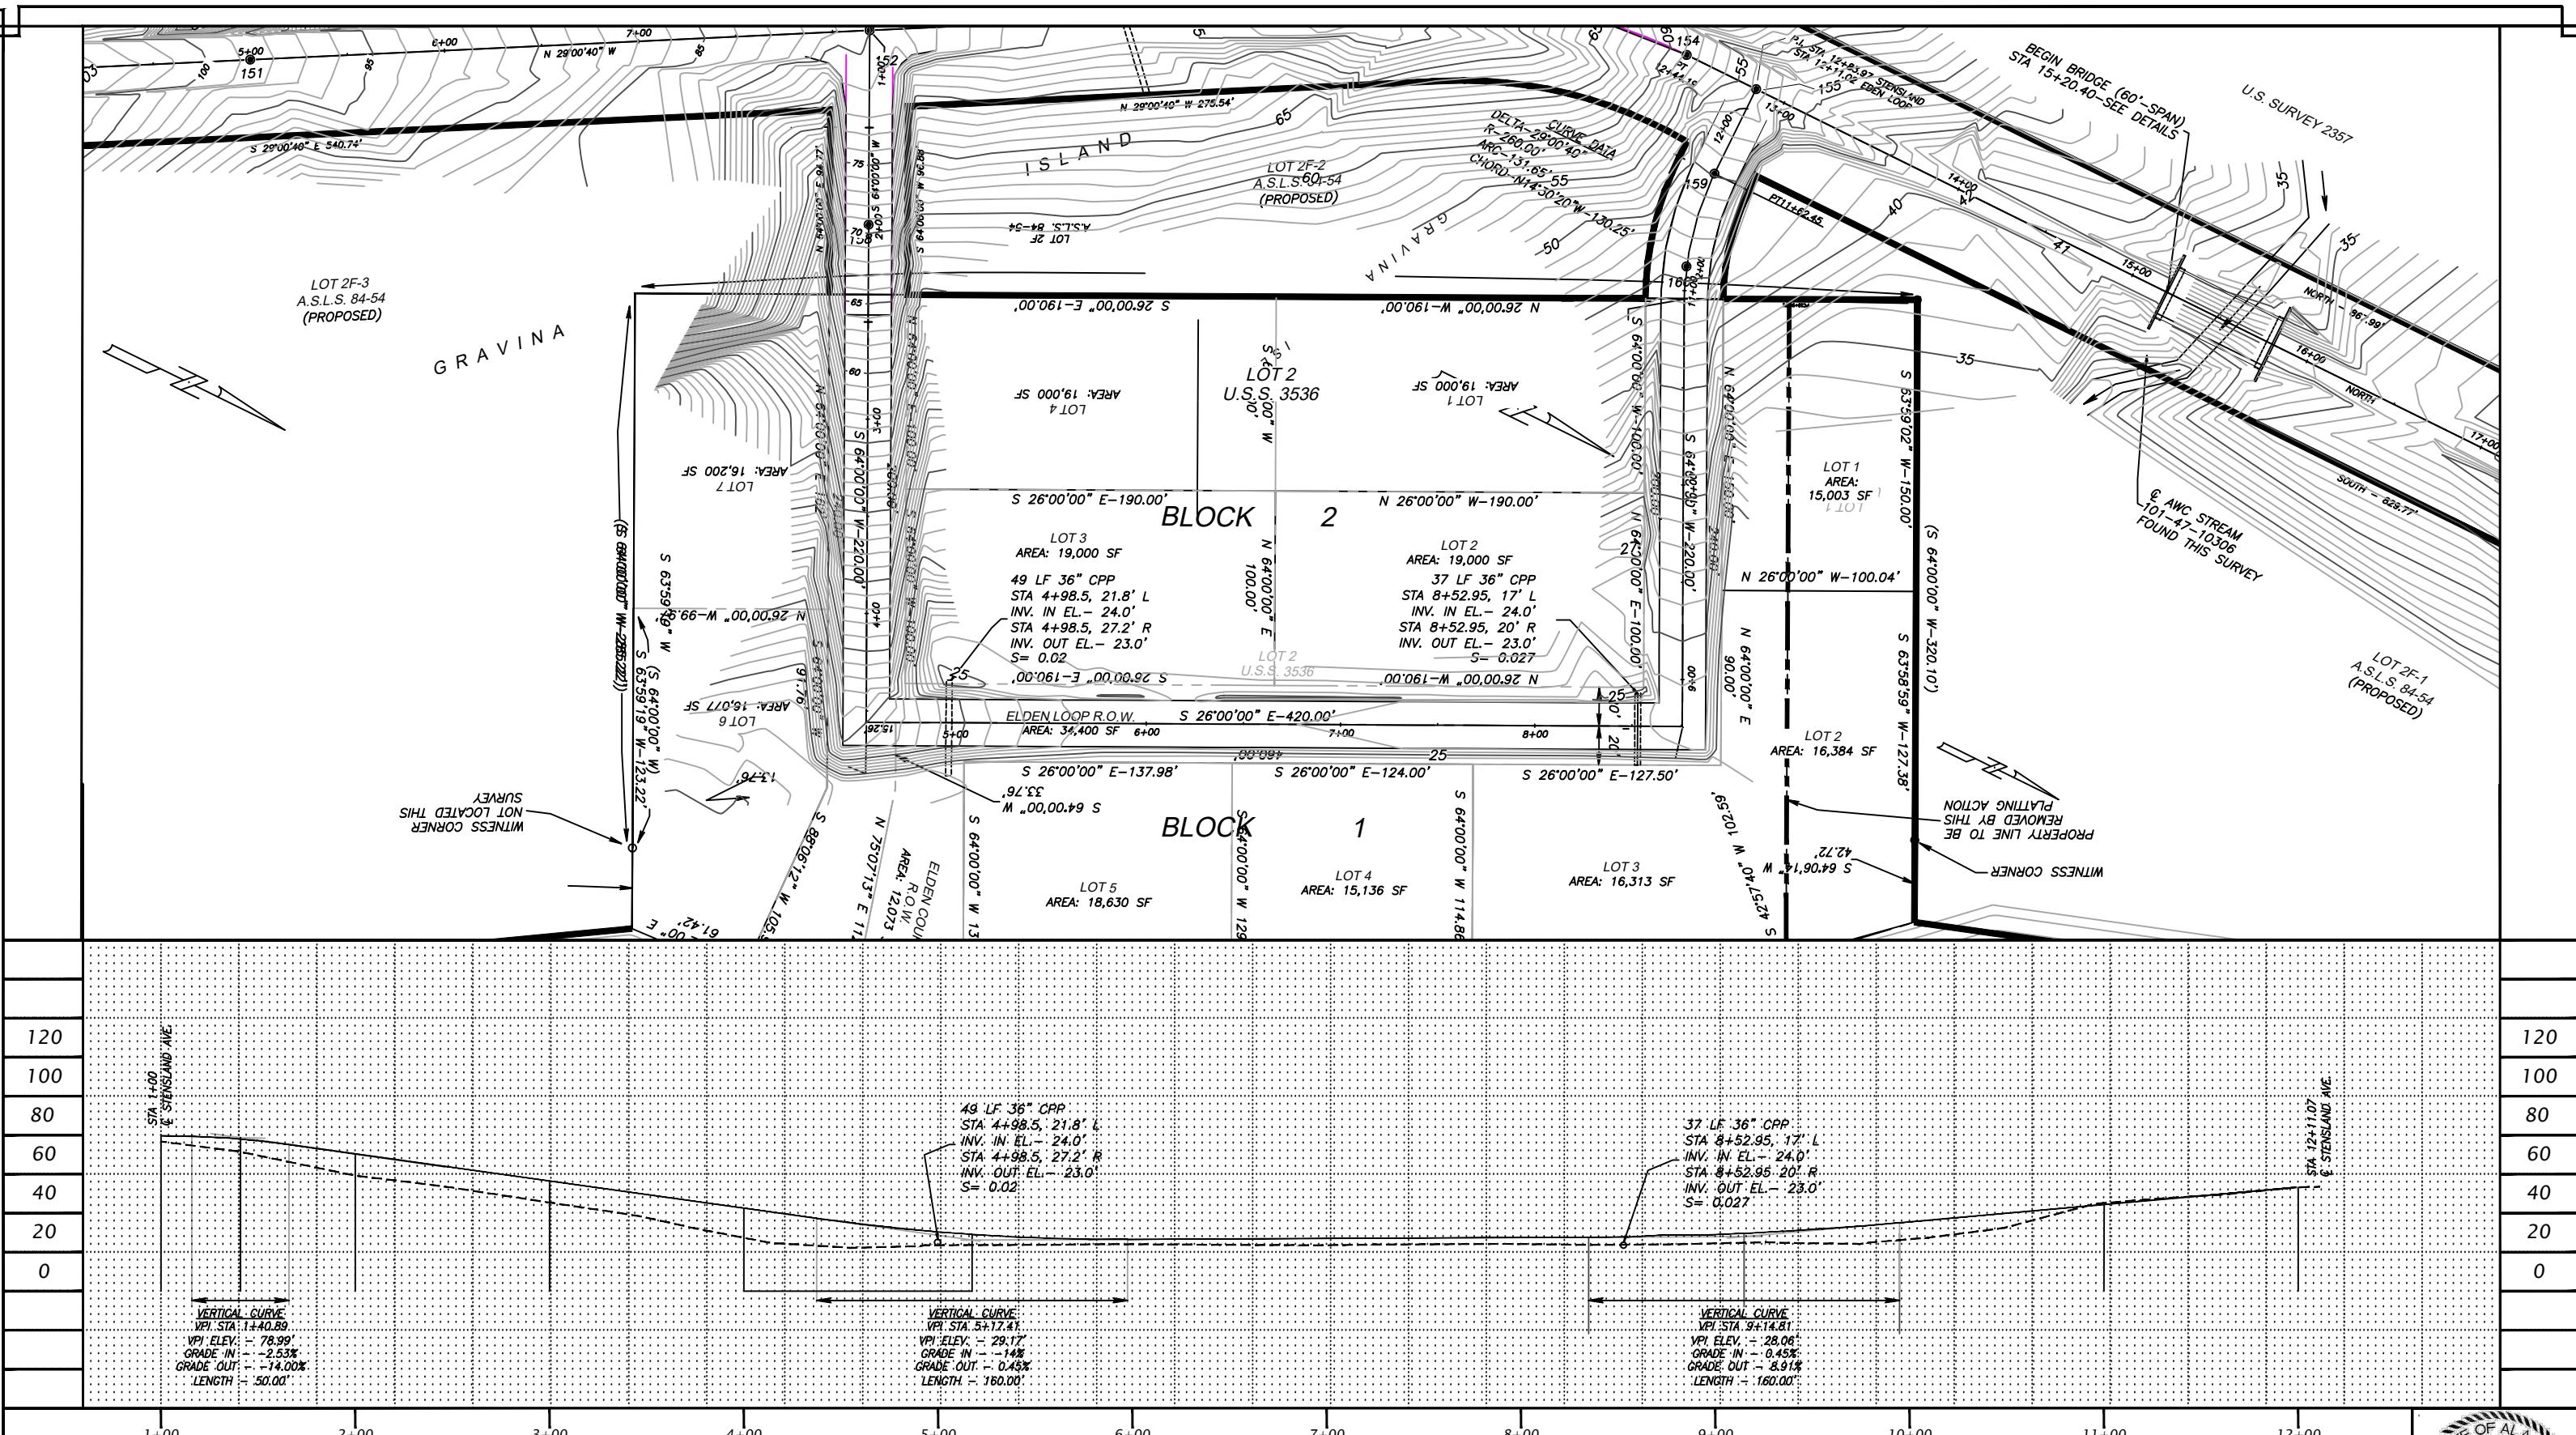

MENZIES ENGINEERING GROUP, INC.  
9737 MUD BAY ROAD, SUITE 301  
KETCHIKAN, ALASKA 99901


PH: (907)-220-9424  
FAX: (907)-220-9425  
EMAIL: [SCOTOMEGALASKA.COM](mailto:SCOTOMEGALASKA.COM)




CLIENT: *CLAM COVE HOLDINGS, LLC*

PROJECT: **ELDEN LOOP ROAD DESIGN**  
**KETCHIKAN, ALASKA**


SHEET DESCRIPTION:  
**ROAD PLAN AND PROFILE**  
**STA 1+00 - 12+15**

	DESIGNED: SAM	APPROVED: SAM	SHEET NO.
	DRAWN: SAM	SCALE: 1" = 40'	DATE: 2/2/2024
DESCRIPTION			
REVISIONS	BY	CHECKED: SAM	PROJECT NO. 23701



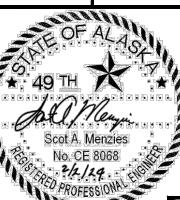


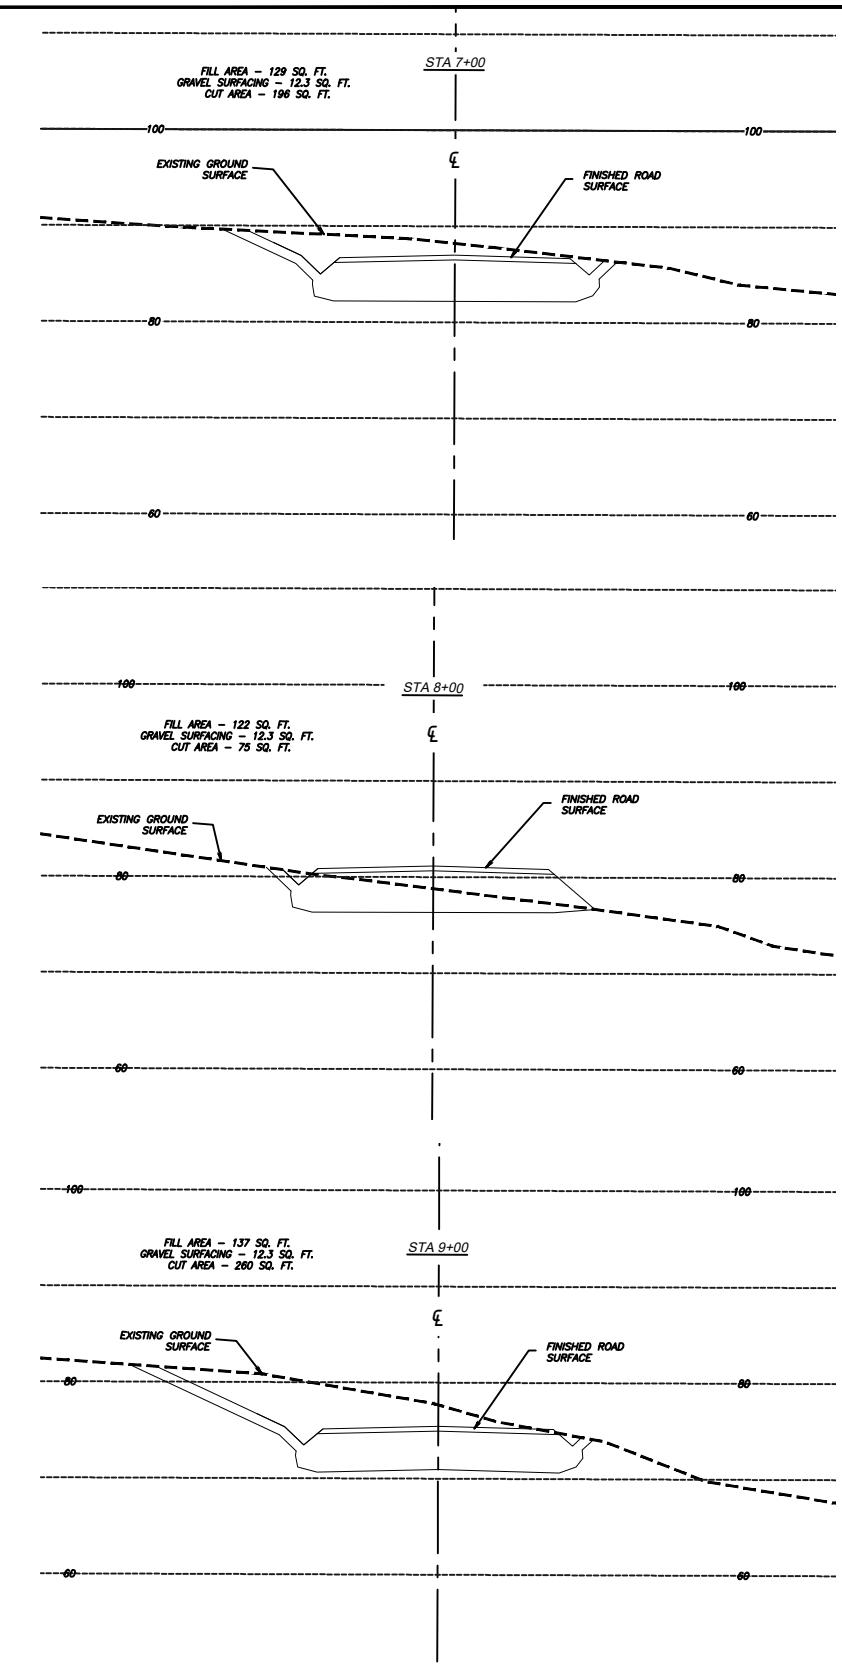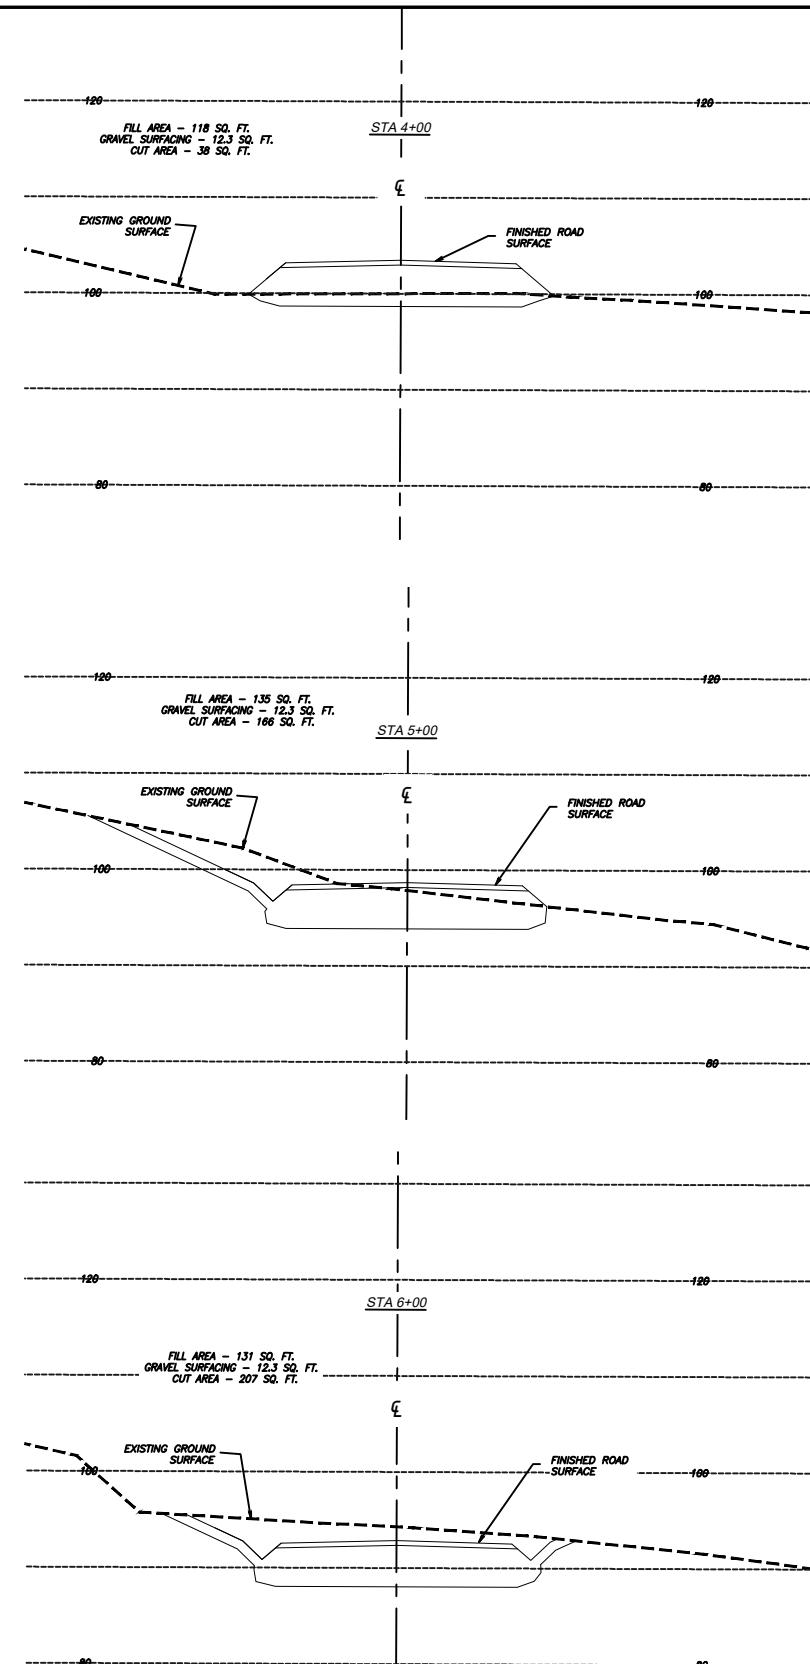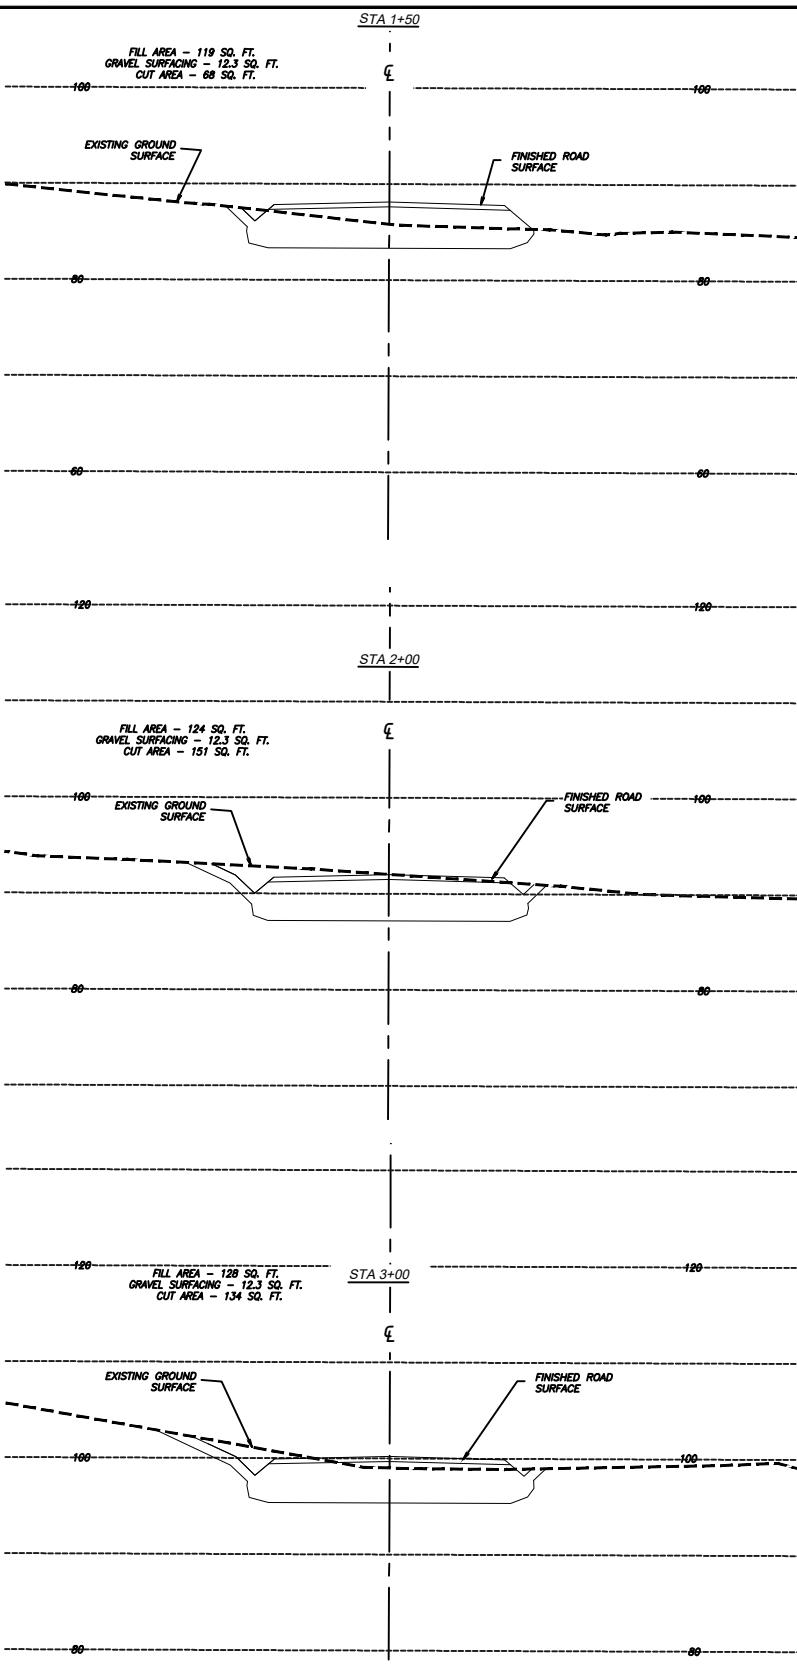

A graphic scale with markings at 0 and 10 feet.

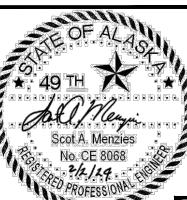

 <p>MENZIES ENGINEERING GROUP, INC. 9737 MUD BAY ROAD, SUITE 301 KETCHIKAN, ALASKA 99901</p> <p>PH: (907)-220-9424 FAX: (907)-220-9425 EMAIL: SCOT@MEGALASKA.COM</p>	CLIENT:	PROJECT:	SHEET DESCRIPTION:			DESIGNED:	SAM	APPROVED:	SAM	SHEET NO.	
	CLAM COVE HOLDINGS, LLC	STENSLAND AVENUE DESIGN KETCHIKAN, ALASKA	STENSLAND AVENUE SECTIONS STA 1+25 - 9+00			DRAWN:	SAM	SCALE:	1" = 10'	DATE:	2/2/2024
						DESCRIPTION					
						REVISIONS					
						DATE	NO.	BY	CHECKED:	PROJECT NO.	23701

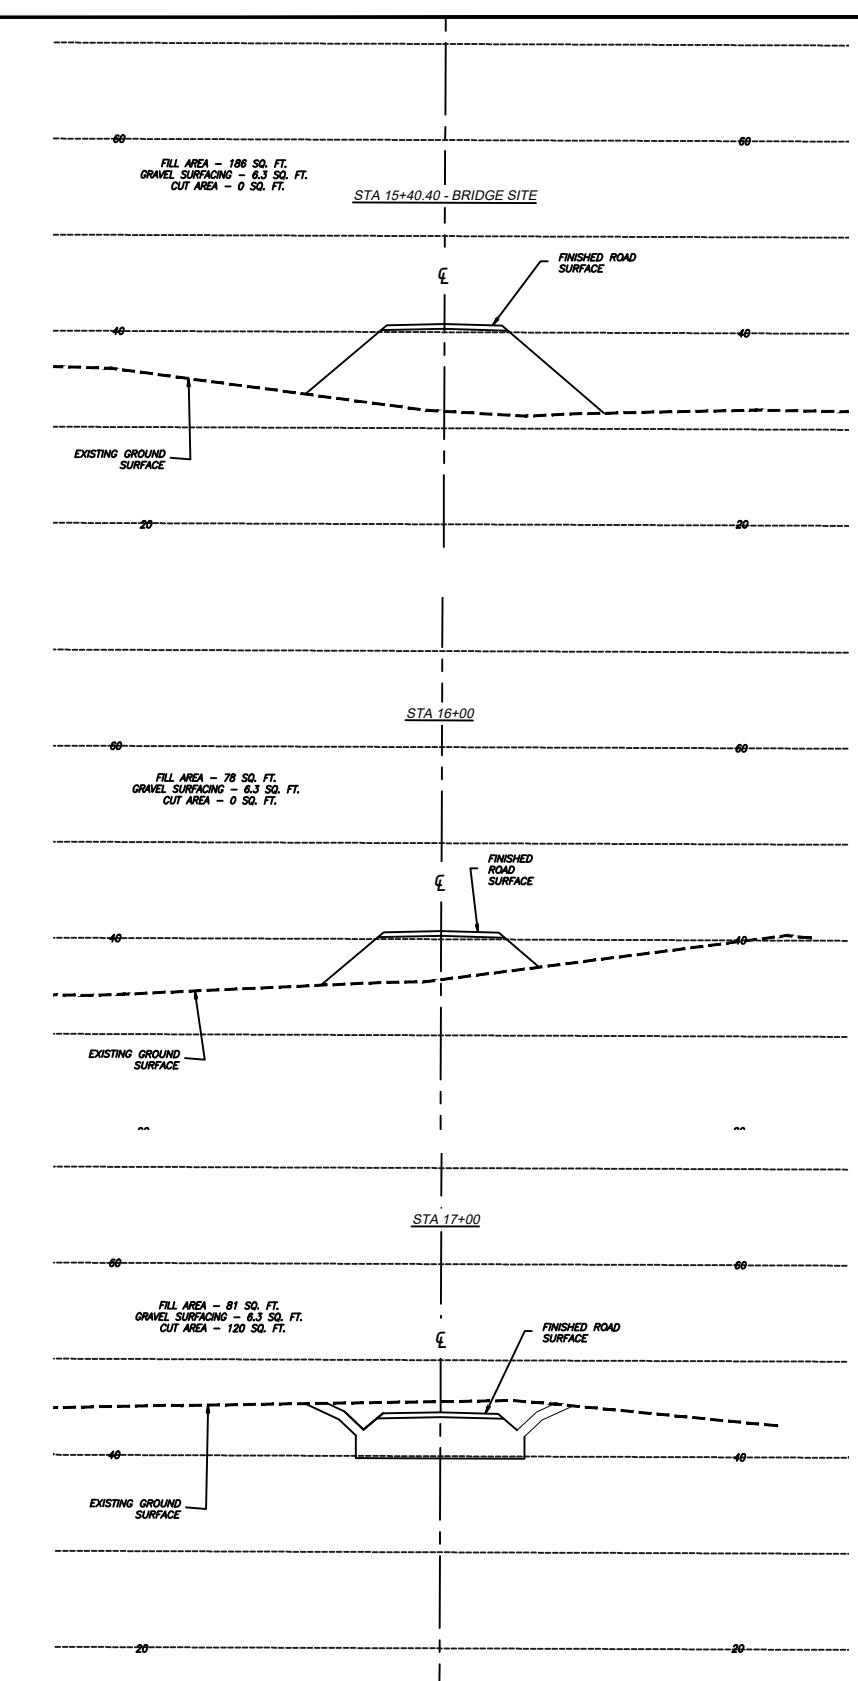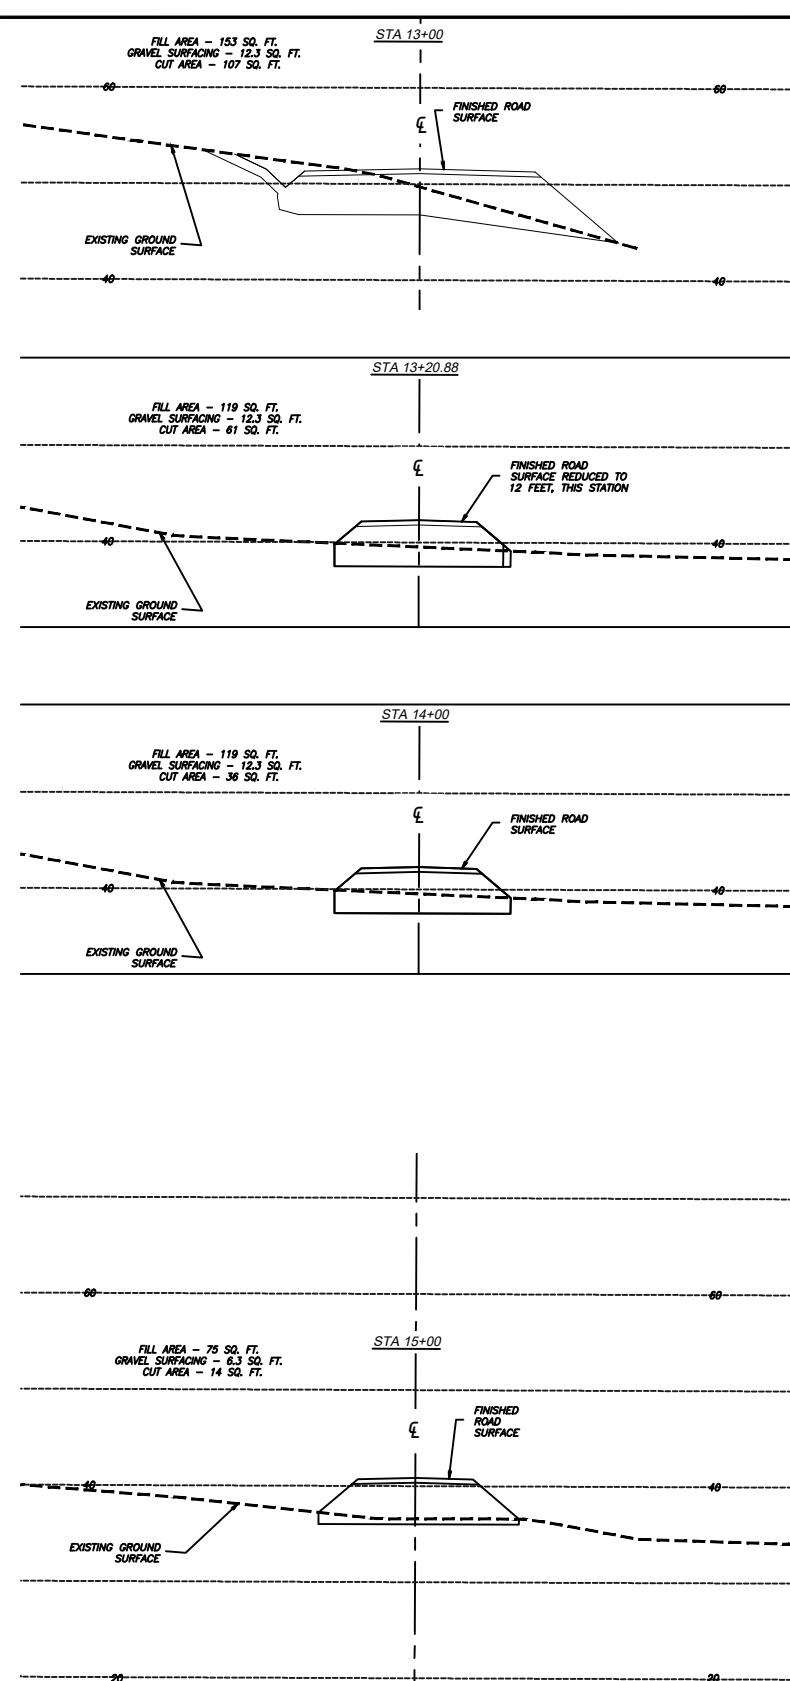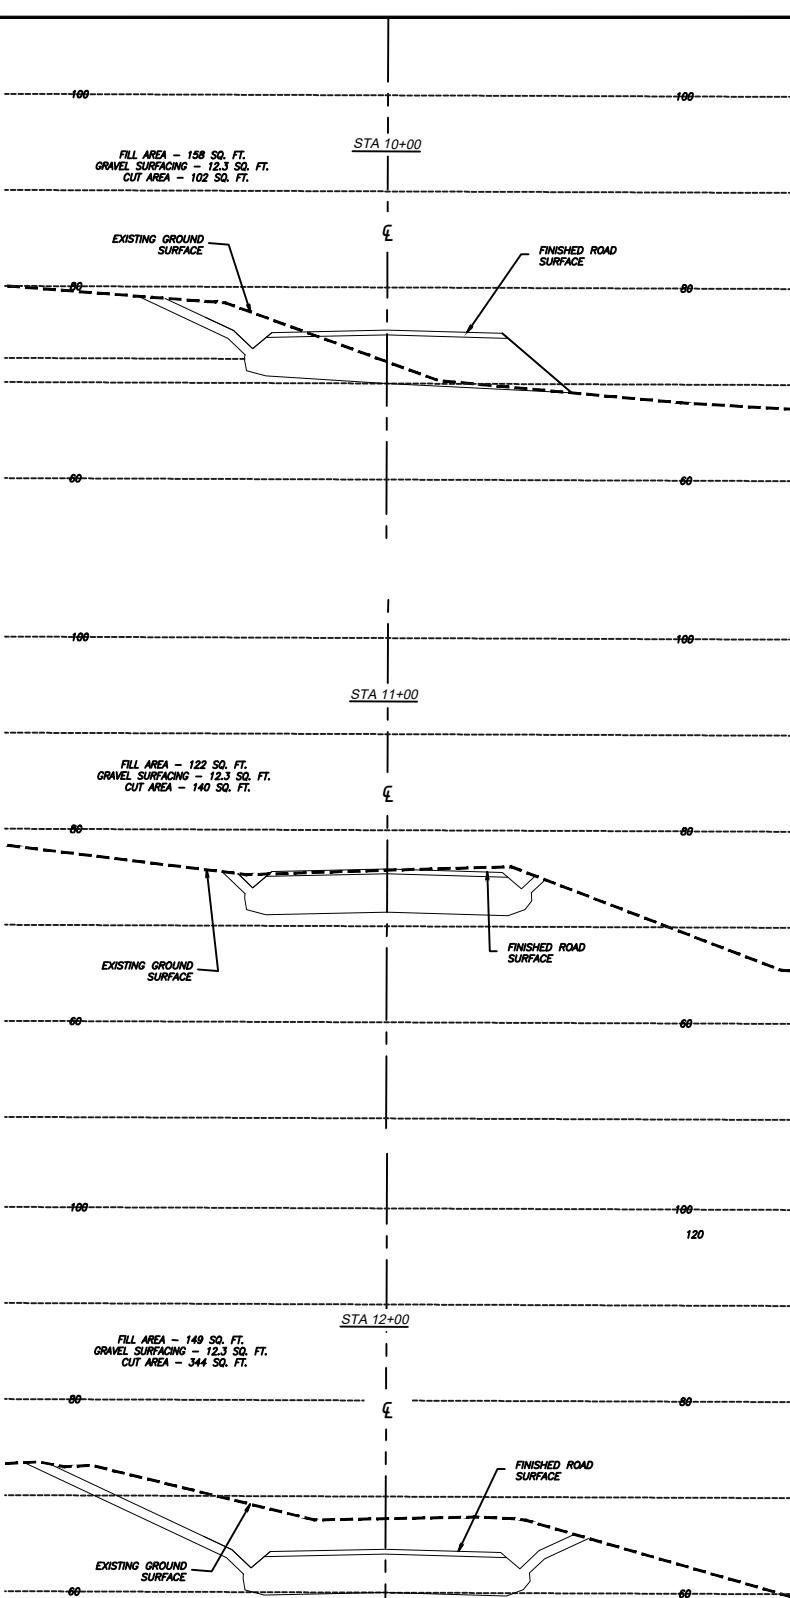

MENZIES ENGINEERING GROUP, INC.  
9737 MUD BAY ROAD, SUITE 301  
KETCHIKAN, ALASKA 99901

PH: (907)-220-9424  
FAX: (907)-220-9425  
EMAIL: SCOT@MEGALASKA.COM

CLIENT:  
**CLAM COVE HOLDINGS, LLC**


PROJECT:

**STENSLAND AVENUE DESIGN  
KETCHIKAN, ALASKA**

SHEET DESCRIPTION:  
**STENSLAND AVENUE SECTIONS STA 10+00 -  
17+00**

DATE NO.	DESCRIPTION	REVISIONS	BY	CHECKED: SAM	PROJECT NO. 23701	DESIGNED: SAM	APPROVED: SAM	SHEET NO. 5.0
						DRAWN: SAM	SCALE: 1" = 10'	DATE: 2/2/2024




GRAPHIC SCALE  
SCALE IN FEET  
5 0 10

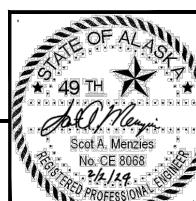


POA-2024-00092

Sheet 11 of 21

February 24, 2025

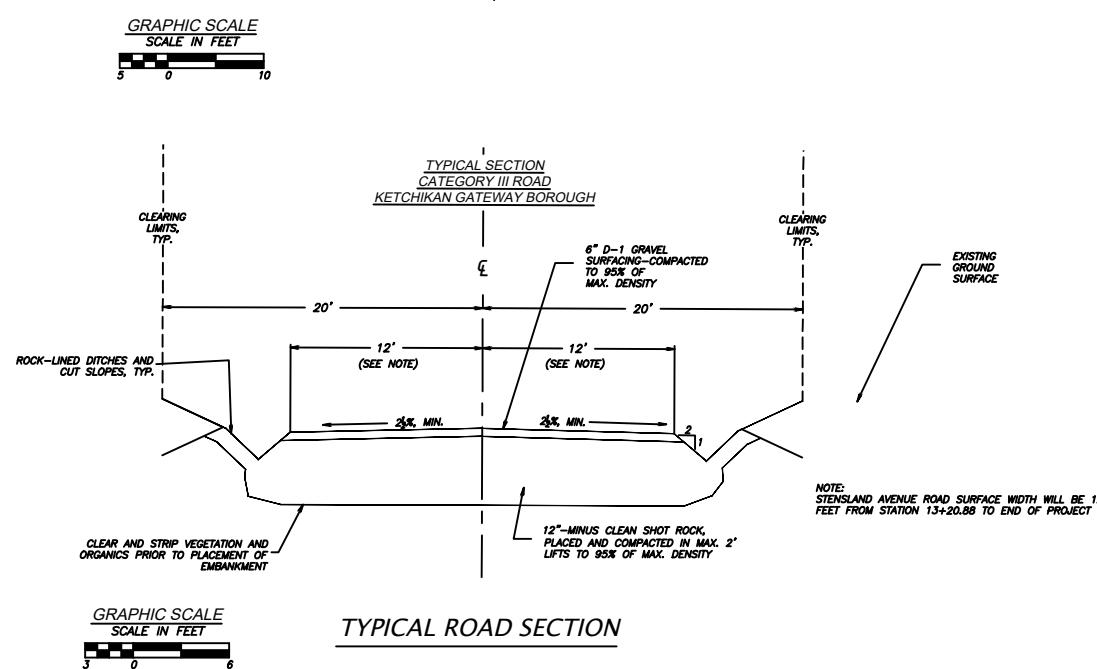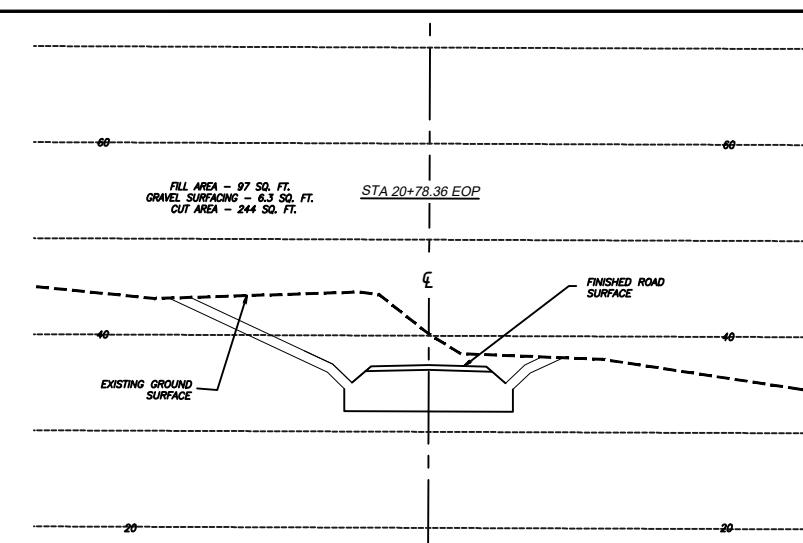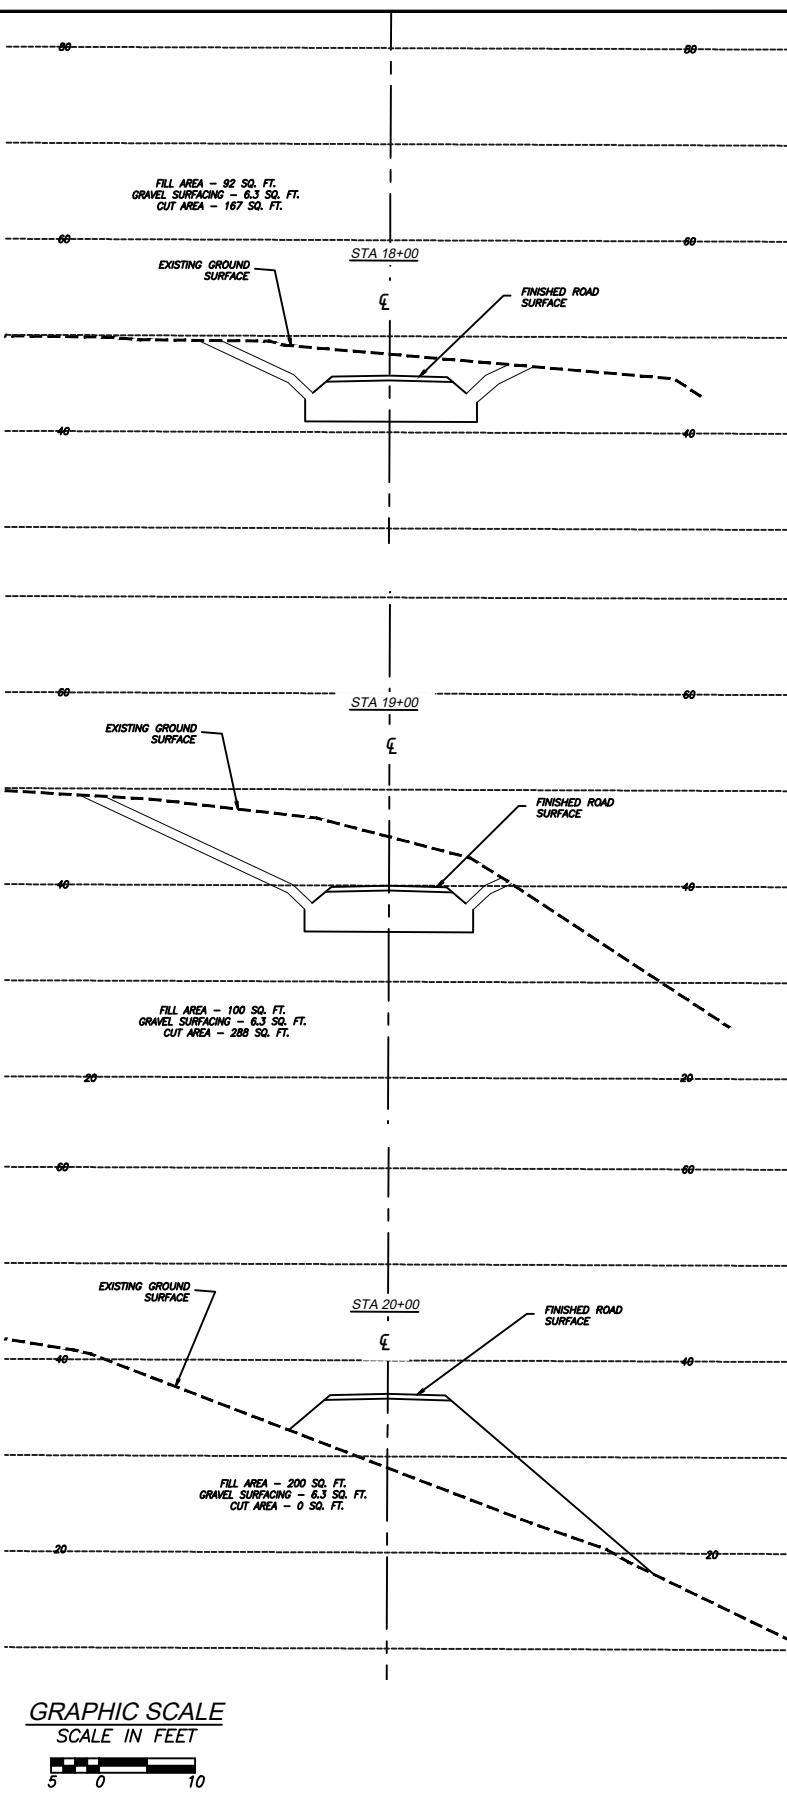


TYPICAL ROAD SECTION

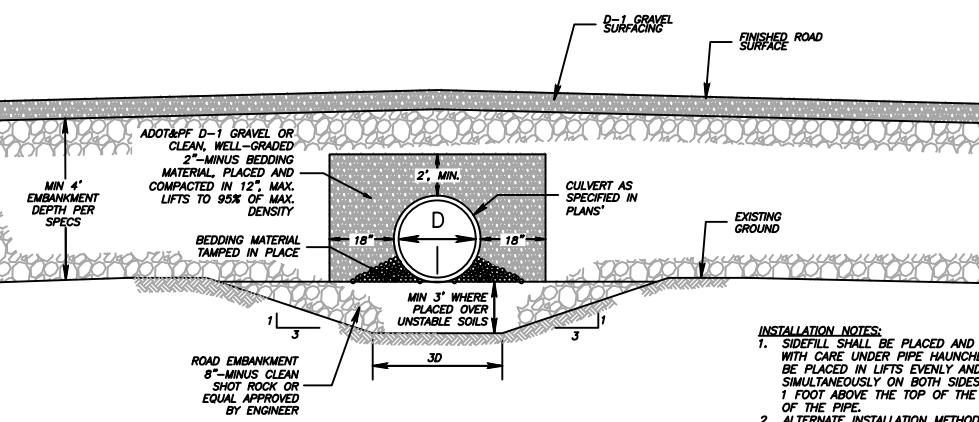

CULVERT FOUNDATION STABILIZATION IN UNYIELDING MATERIAL

NOT TO SCALE

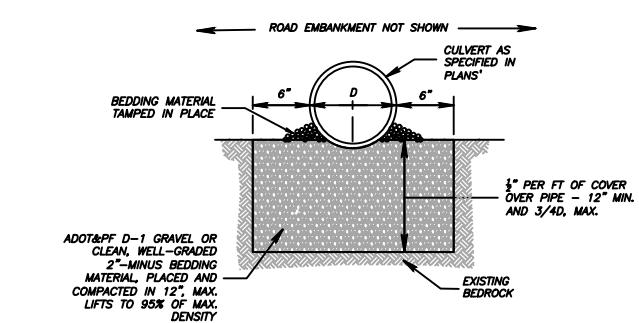

CULVERT FOUNDATION STABILIZATION IN UNYIELDING MATERIAL  
NOT TO SCALE



MENZIES ENGINEERING GROUP, INC.  
9737 MUD BAY ROAD, SUITE 301  
KETCHIKAN, ALASKA 99901


PH: (907)-220-9424  
FAX: (907)-220-9425  
EMAIL: SCOT@MEGALASKA.COM










CLIENT:  
CLAM COVE HOLDINGS, LLC

PROJECT:  
STENSLAND AVENUE DESIGN  
KETCHIKAN, ALASKA

SHEET DESCRIPTION:  
STENSLAND AVENUE SECTIONS STA 18+00 -  
20+78.36 EOP

DATE NO.	DESCRIPTION	REVISIONS	BY	CHECKED: SAM	PROJECT NO.	23701
				DRAWN: SAM	APPROVED: SAM	
				SCALE: AS NOTED	DATE: 2/2/2024	

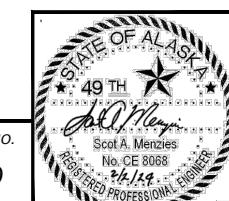

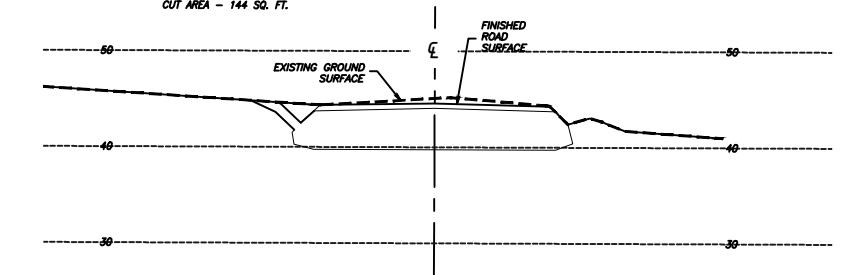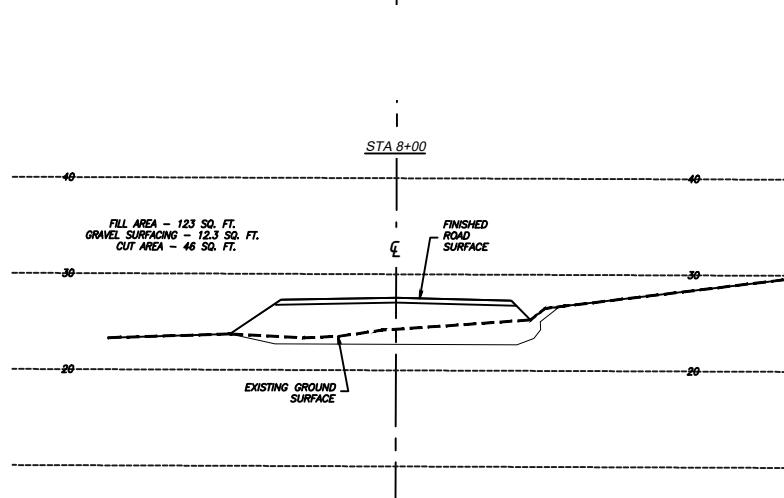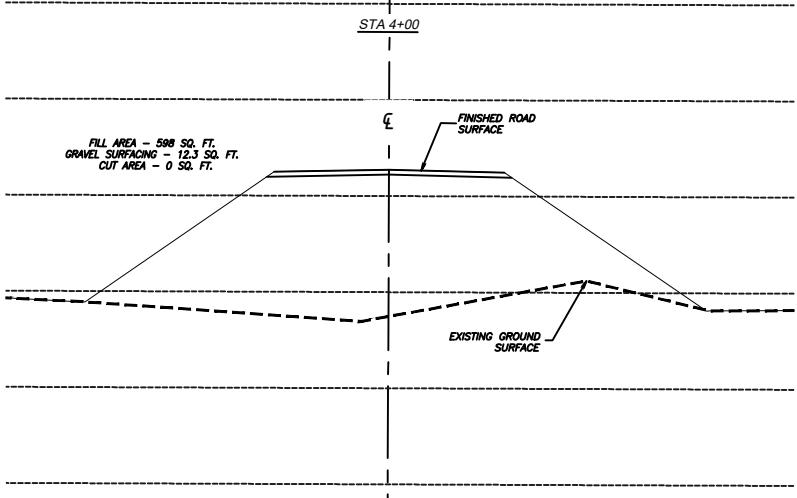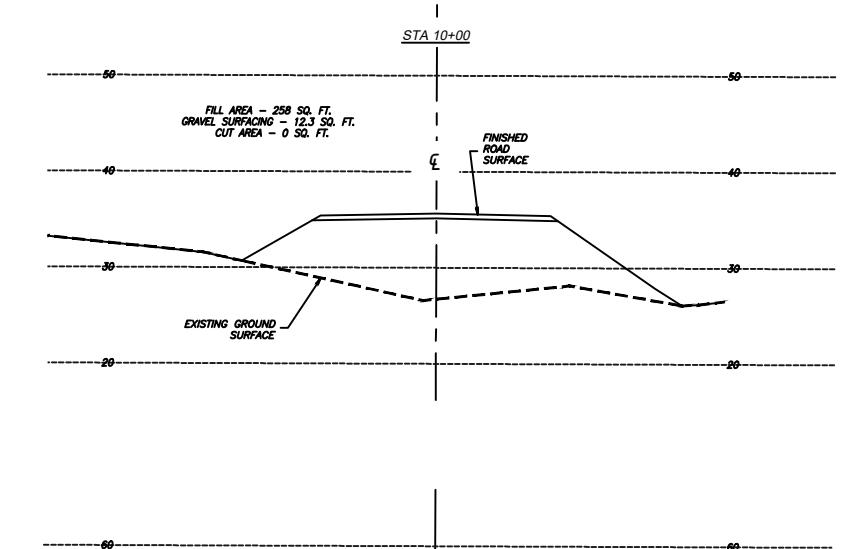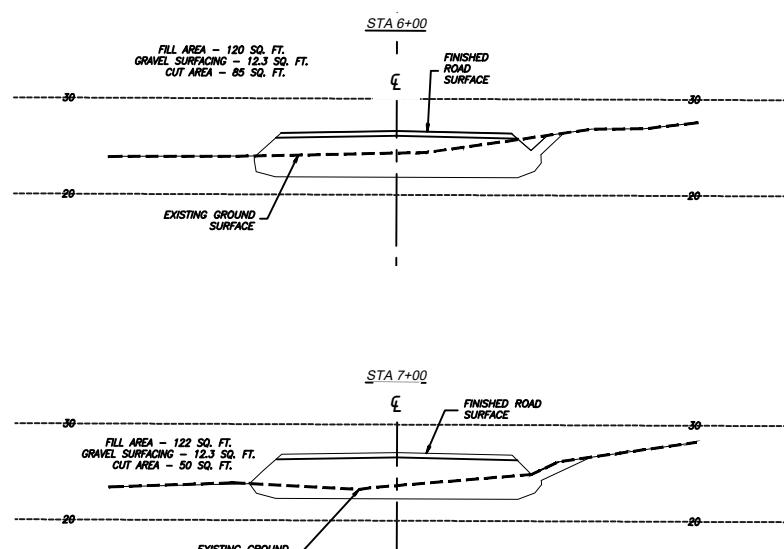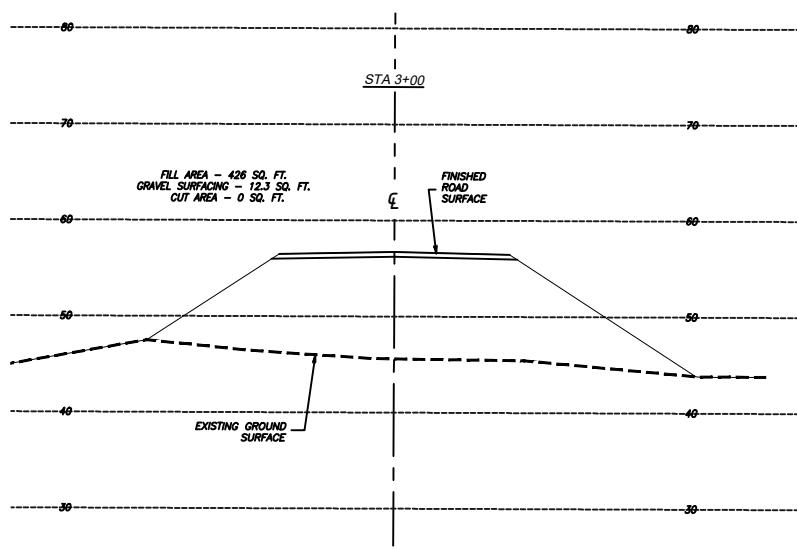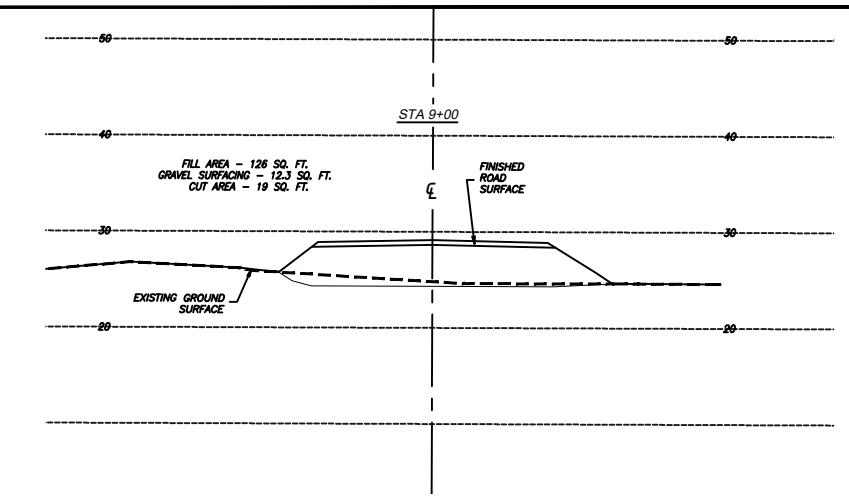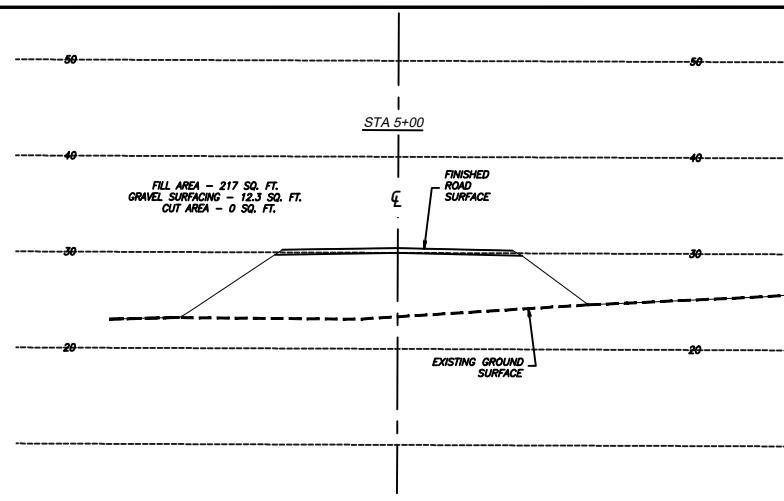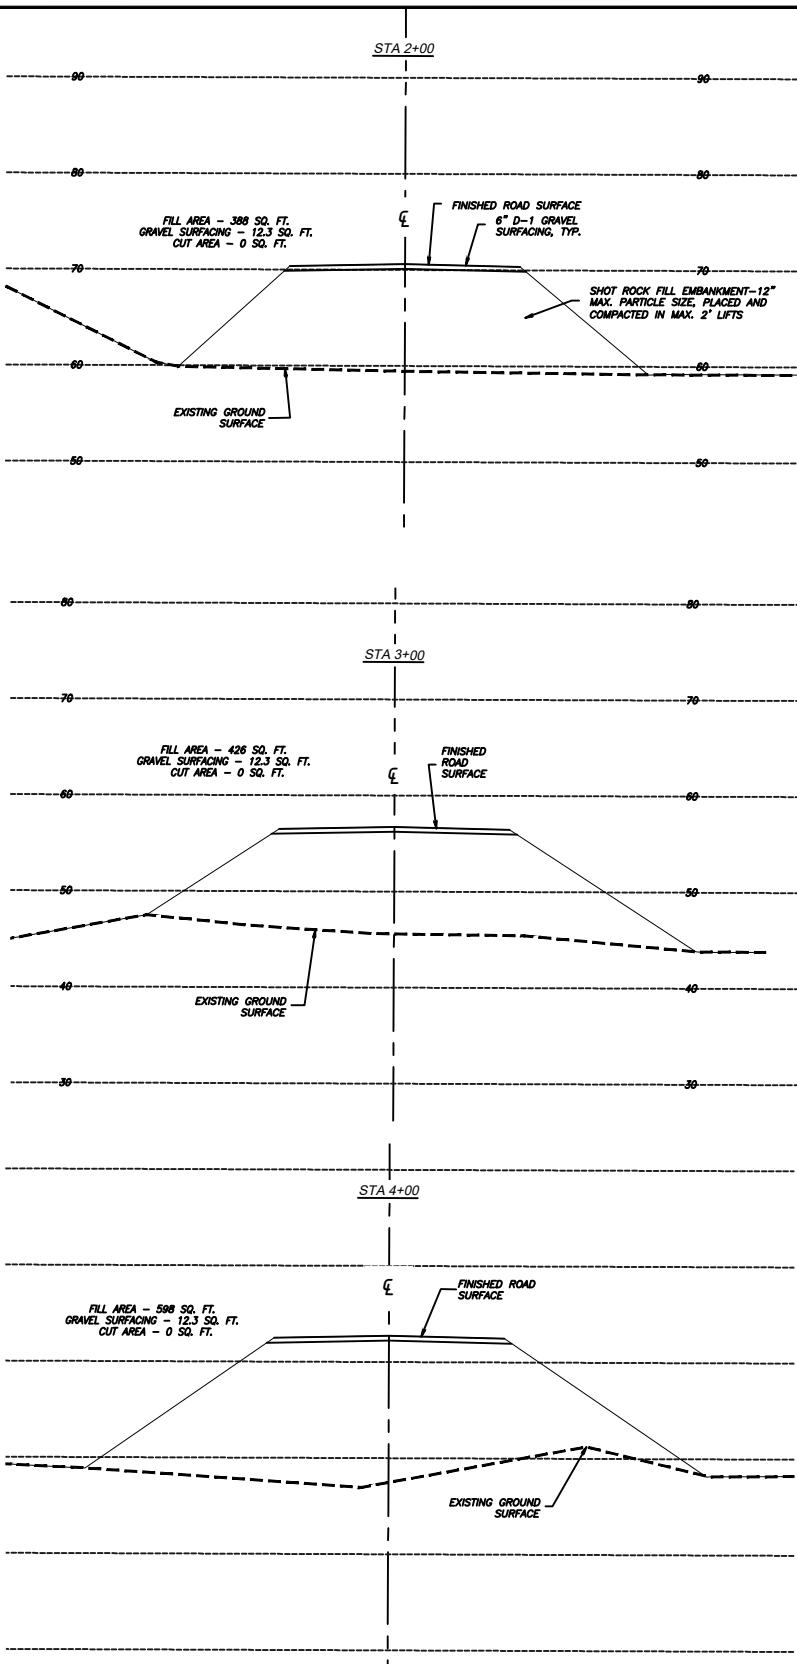

GRAPHIC SCALE  
SCALE IN FEET  
5 0 10



MENZIES ENGINEERING GROUP, INC.  
9737 MUD BAY ROAD, SUITE 301  
KETCHIKAN, ALASKA 99901

PH: (907)-220-9424  
FAX: (907)-220-9425  
EMAIL: SCOT@MEGALASKA.COM

CLIENT:  
**CLAM COVE HOLDINGS, LLC**

PROJECT:

**STENSLAND AVENUE DESIGN  
KETCHIKAN, ALASKA**





SHEET DESCRIPTION:  
**ELDEN LOOP ROAD SECTIONS STA 2+00 -  
12+00**


DATE NO.	DESCRIPTION	REVISIONS	BY	CHECKED: SAM	PROJECT NO. 23701	DESIGNED: SAM	APPROVED: SAM	SHEET NO. 7.0
						DRAWN: SAM	SCALE: 1" = 10'	DATE: 2/2/2024


POA-2024-00092



Sheet 13 of 21

February 24, 2025

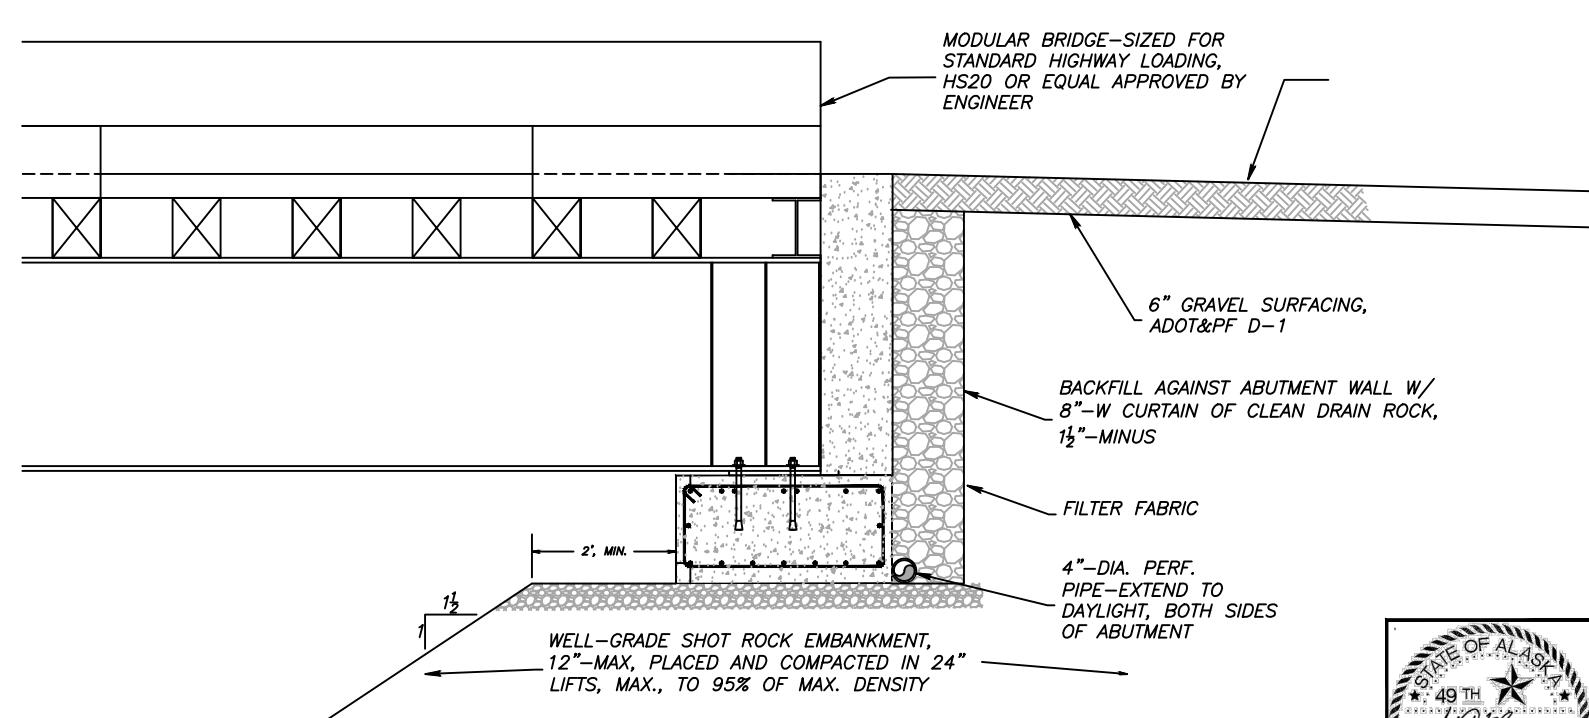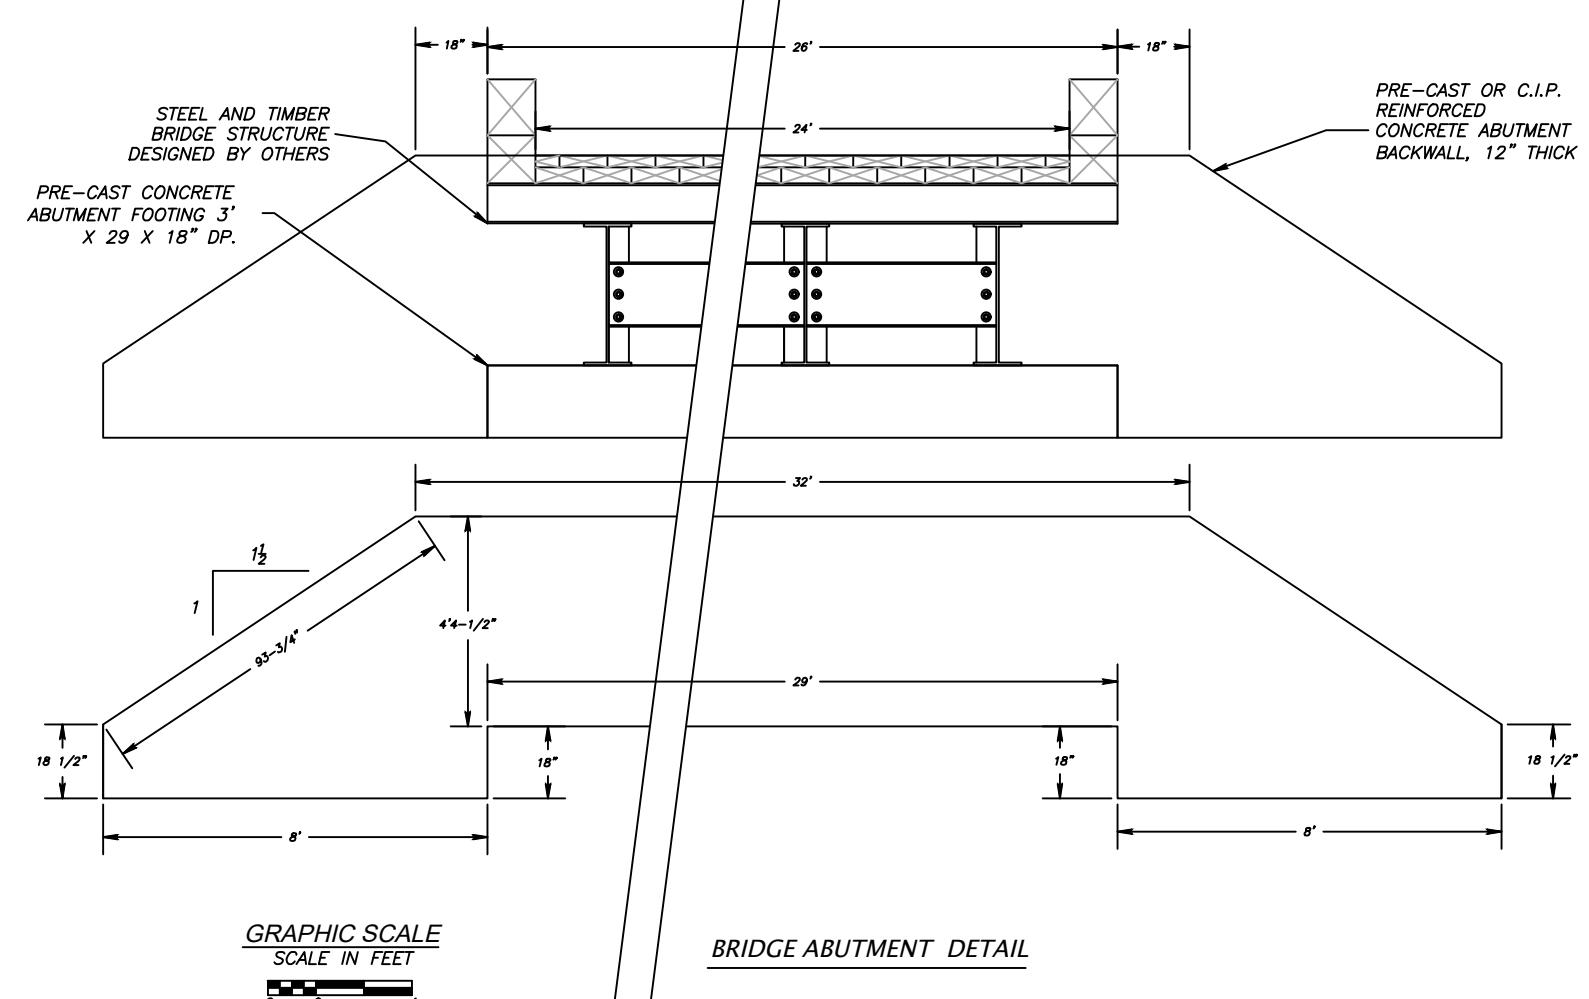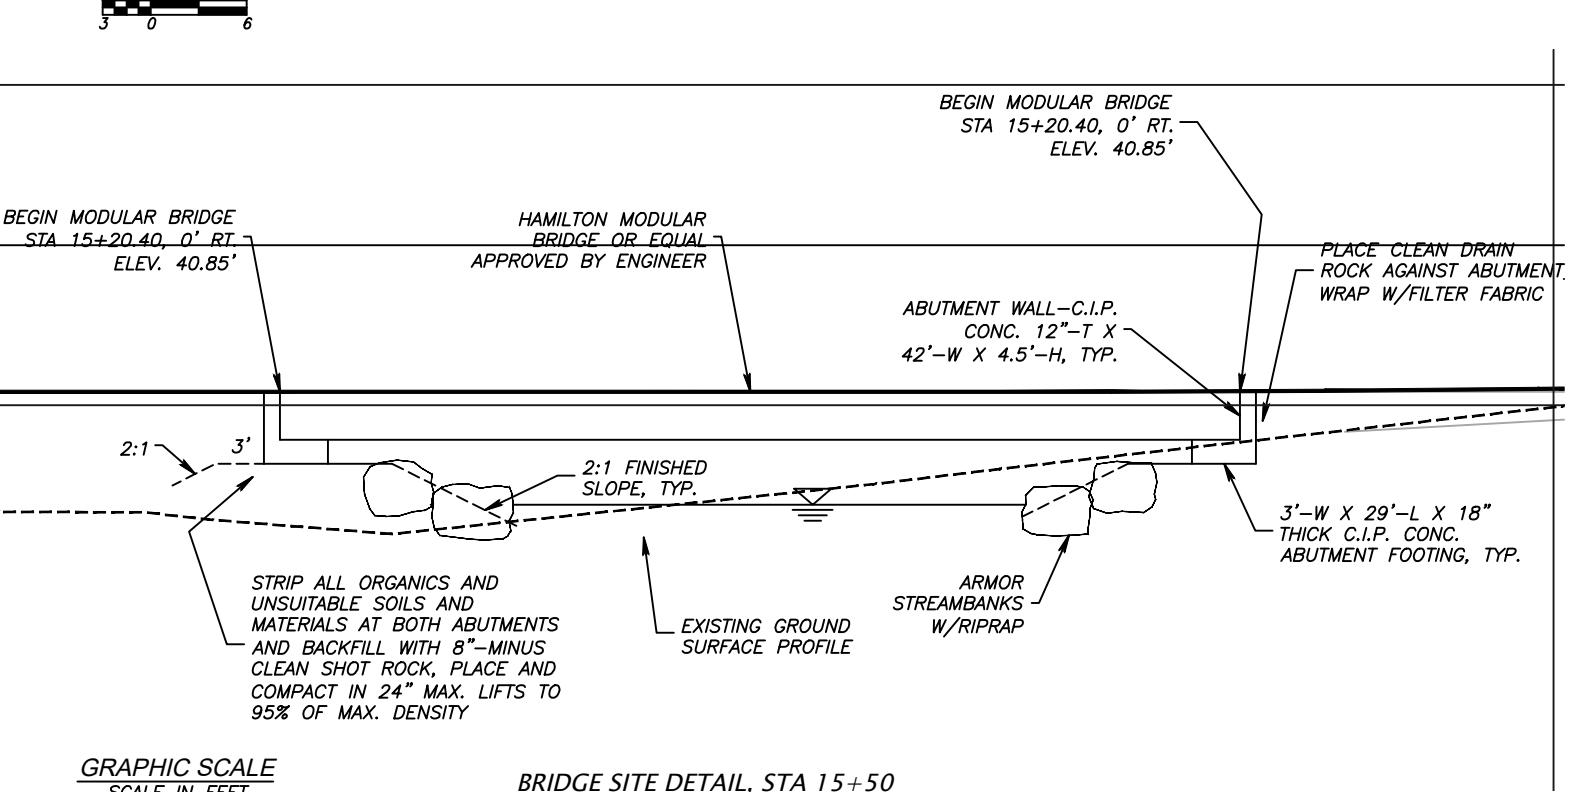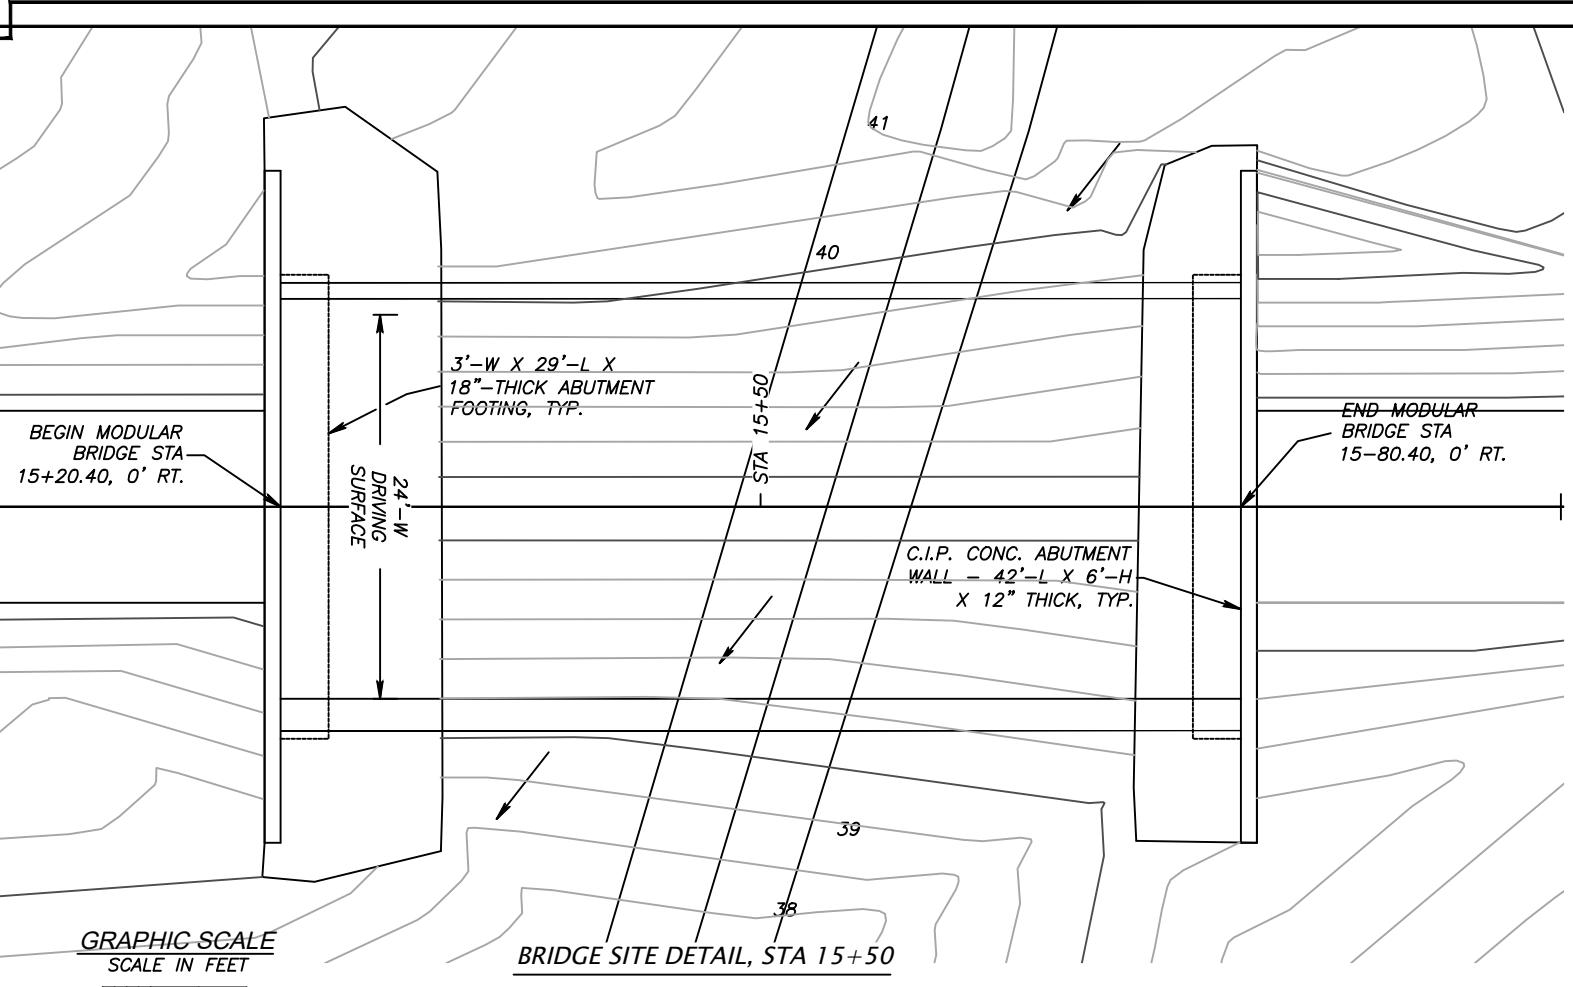

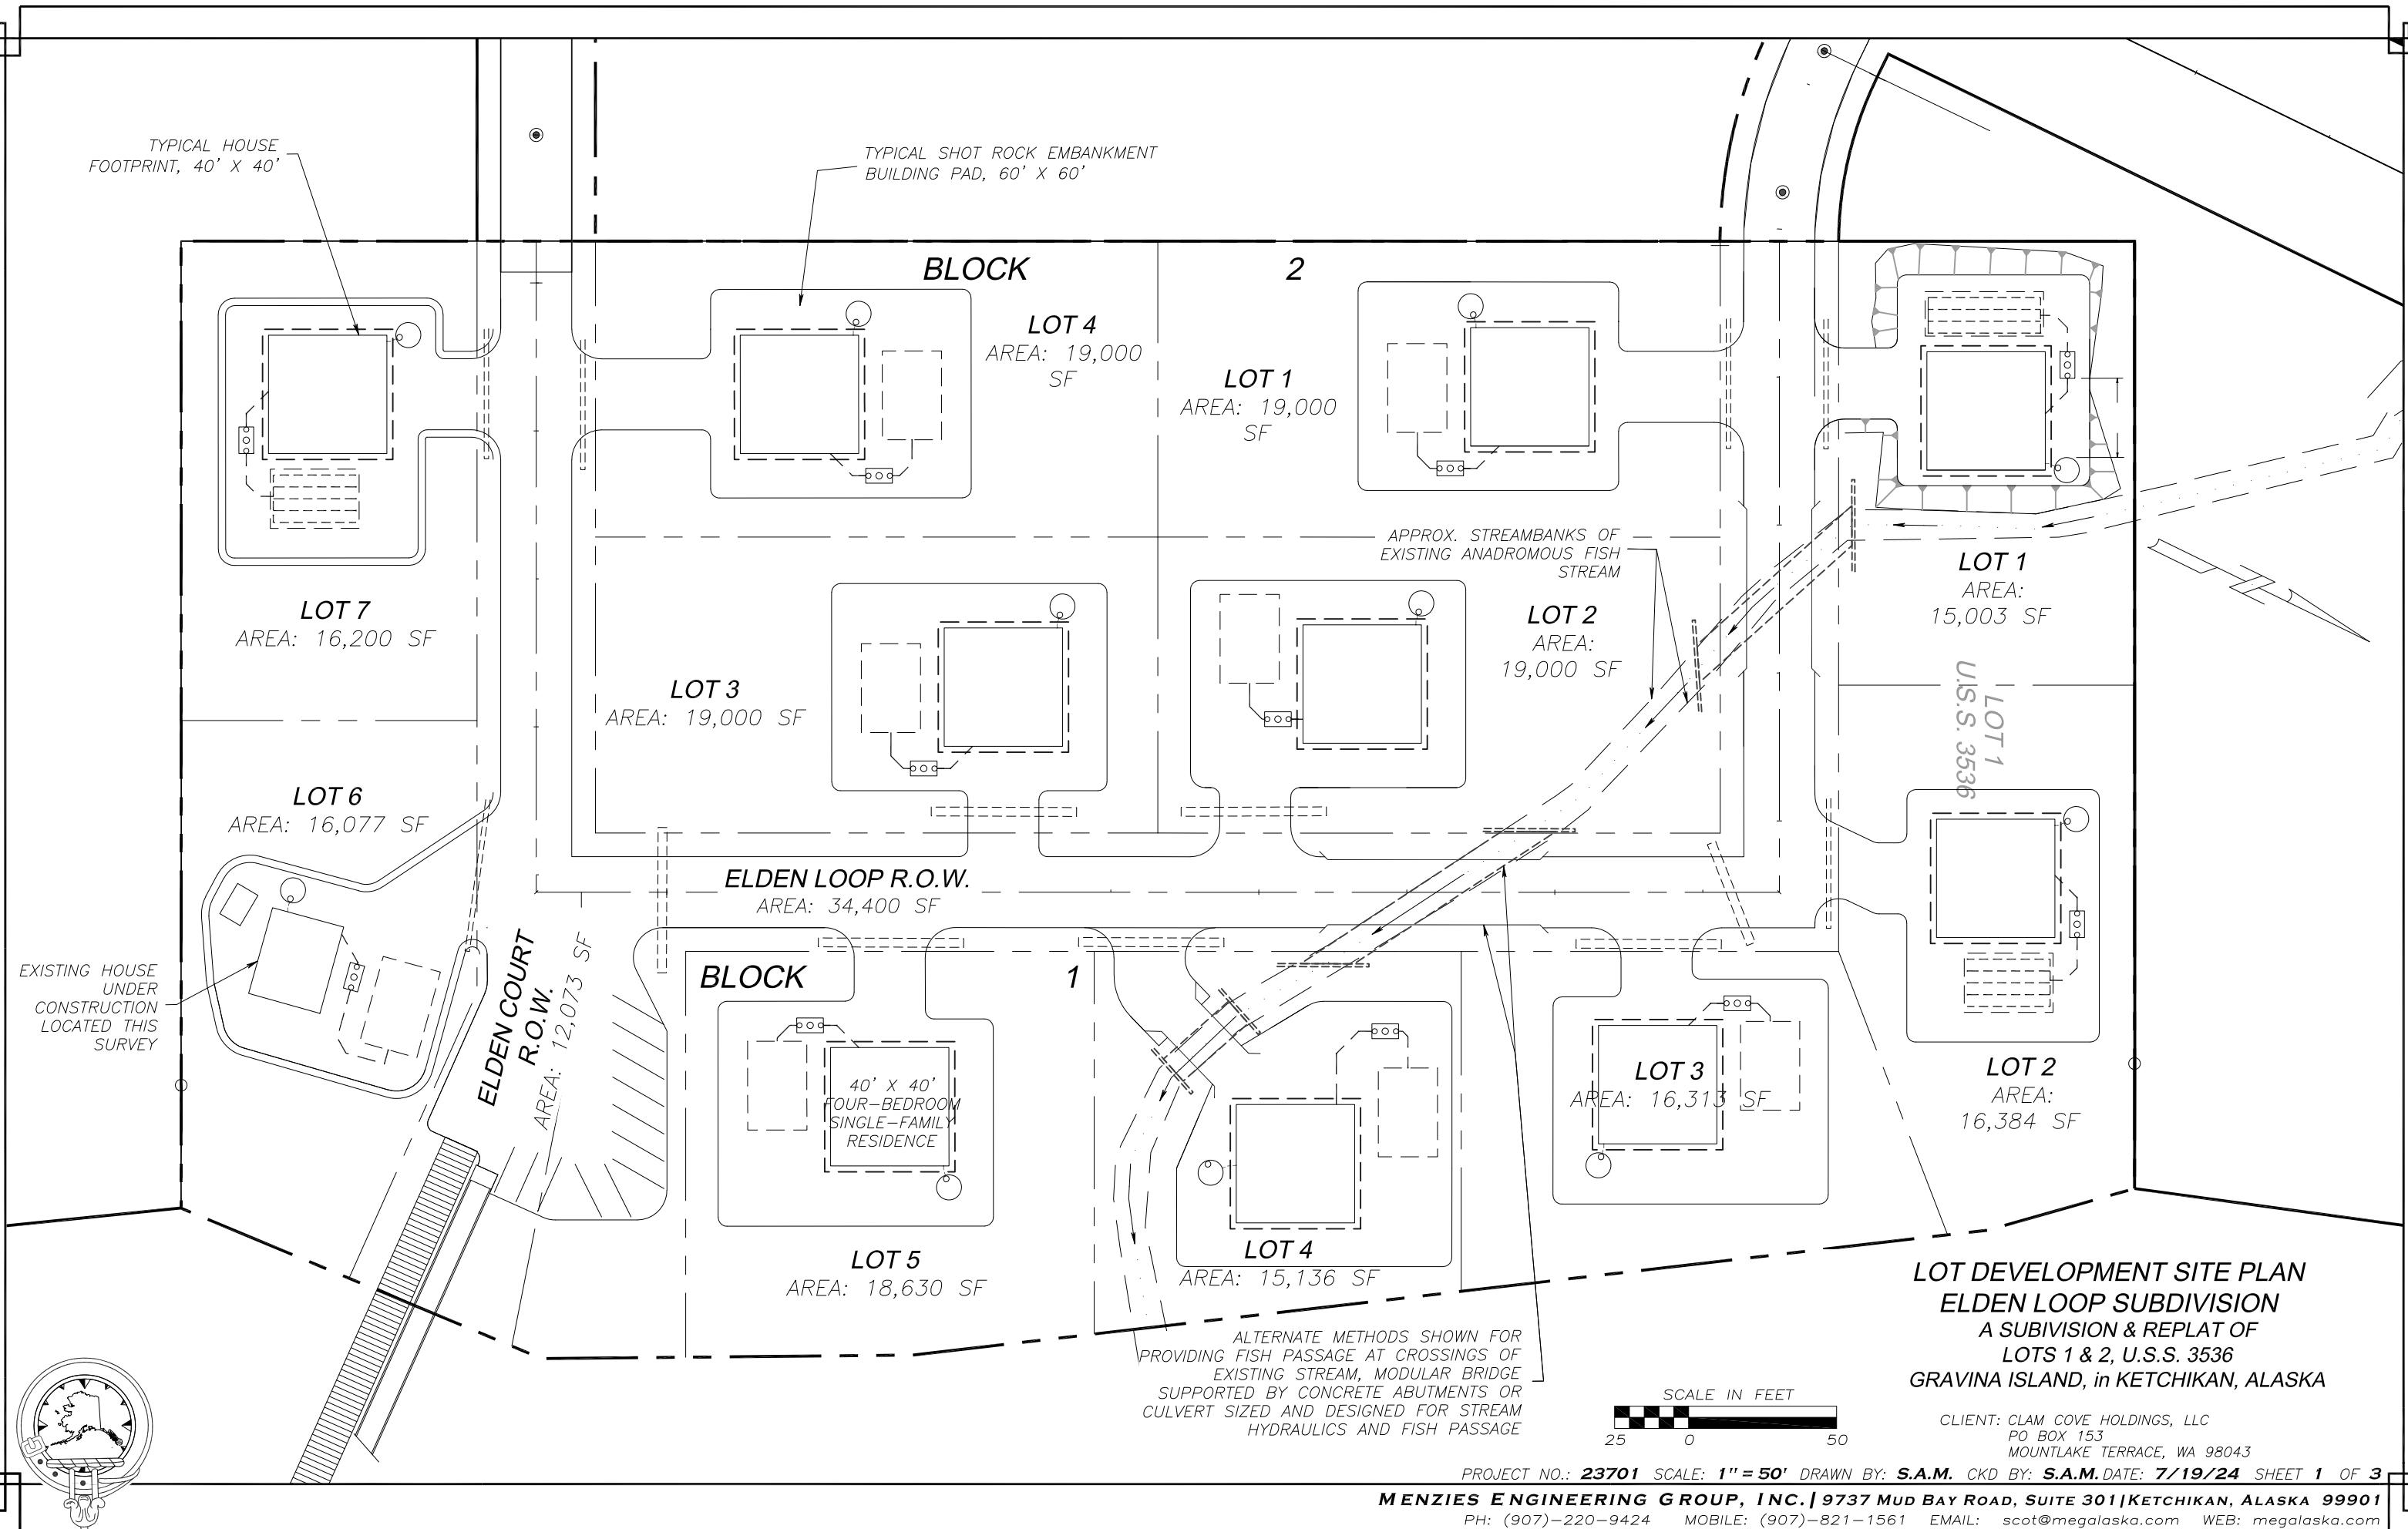

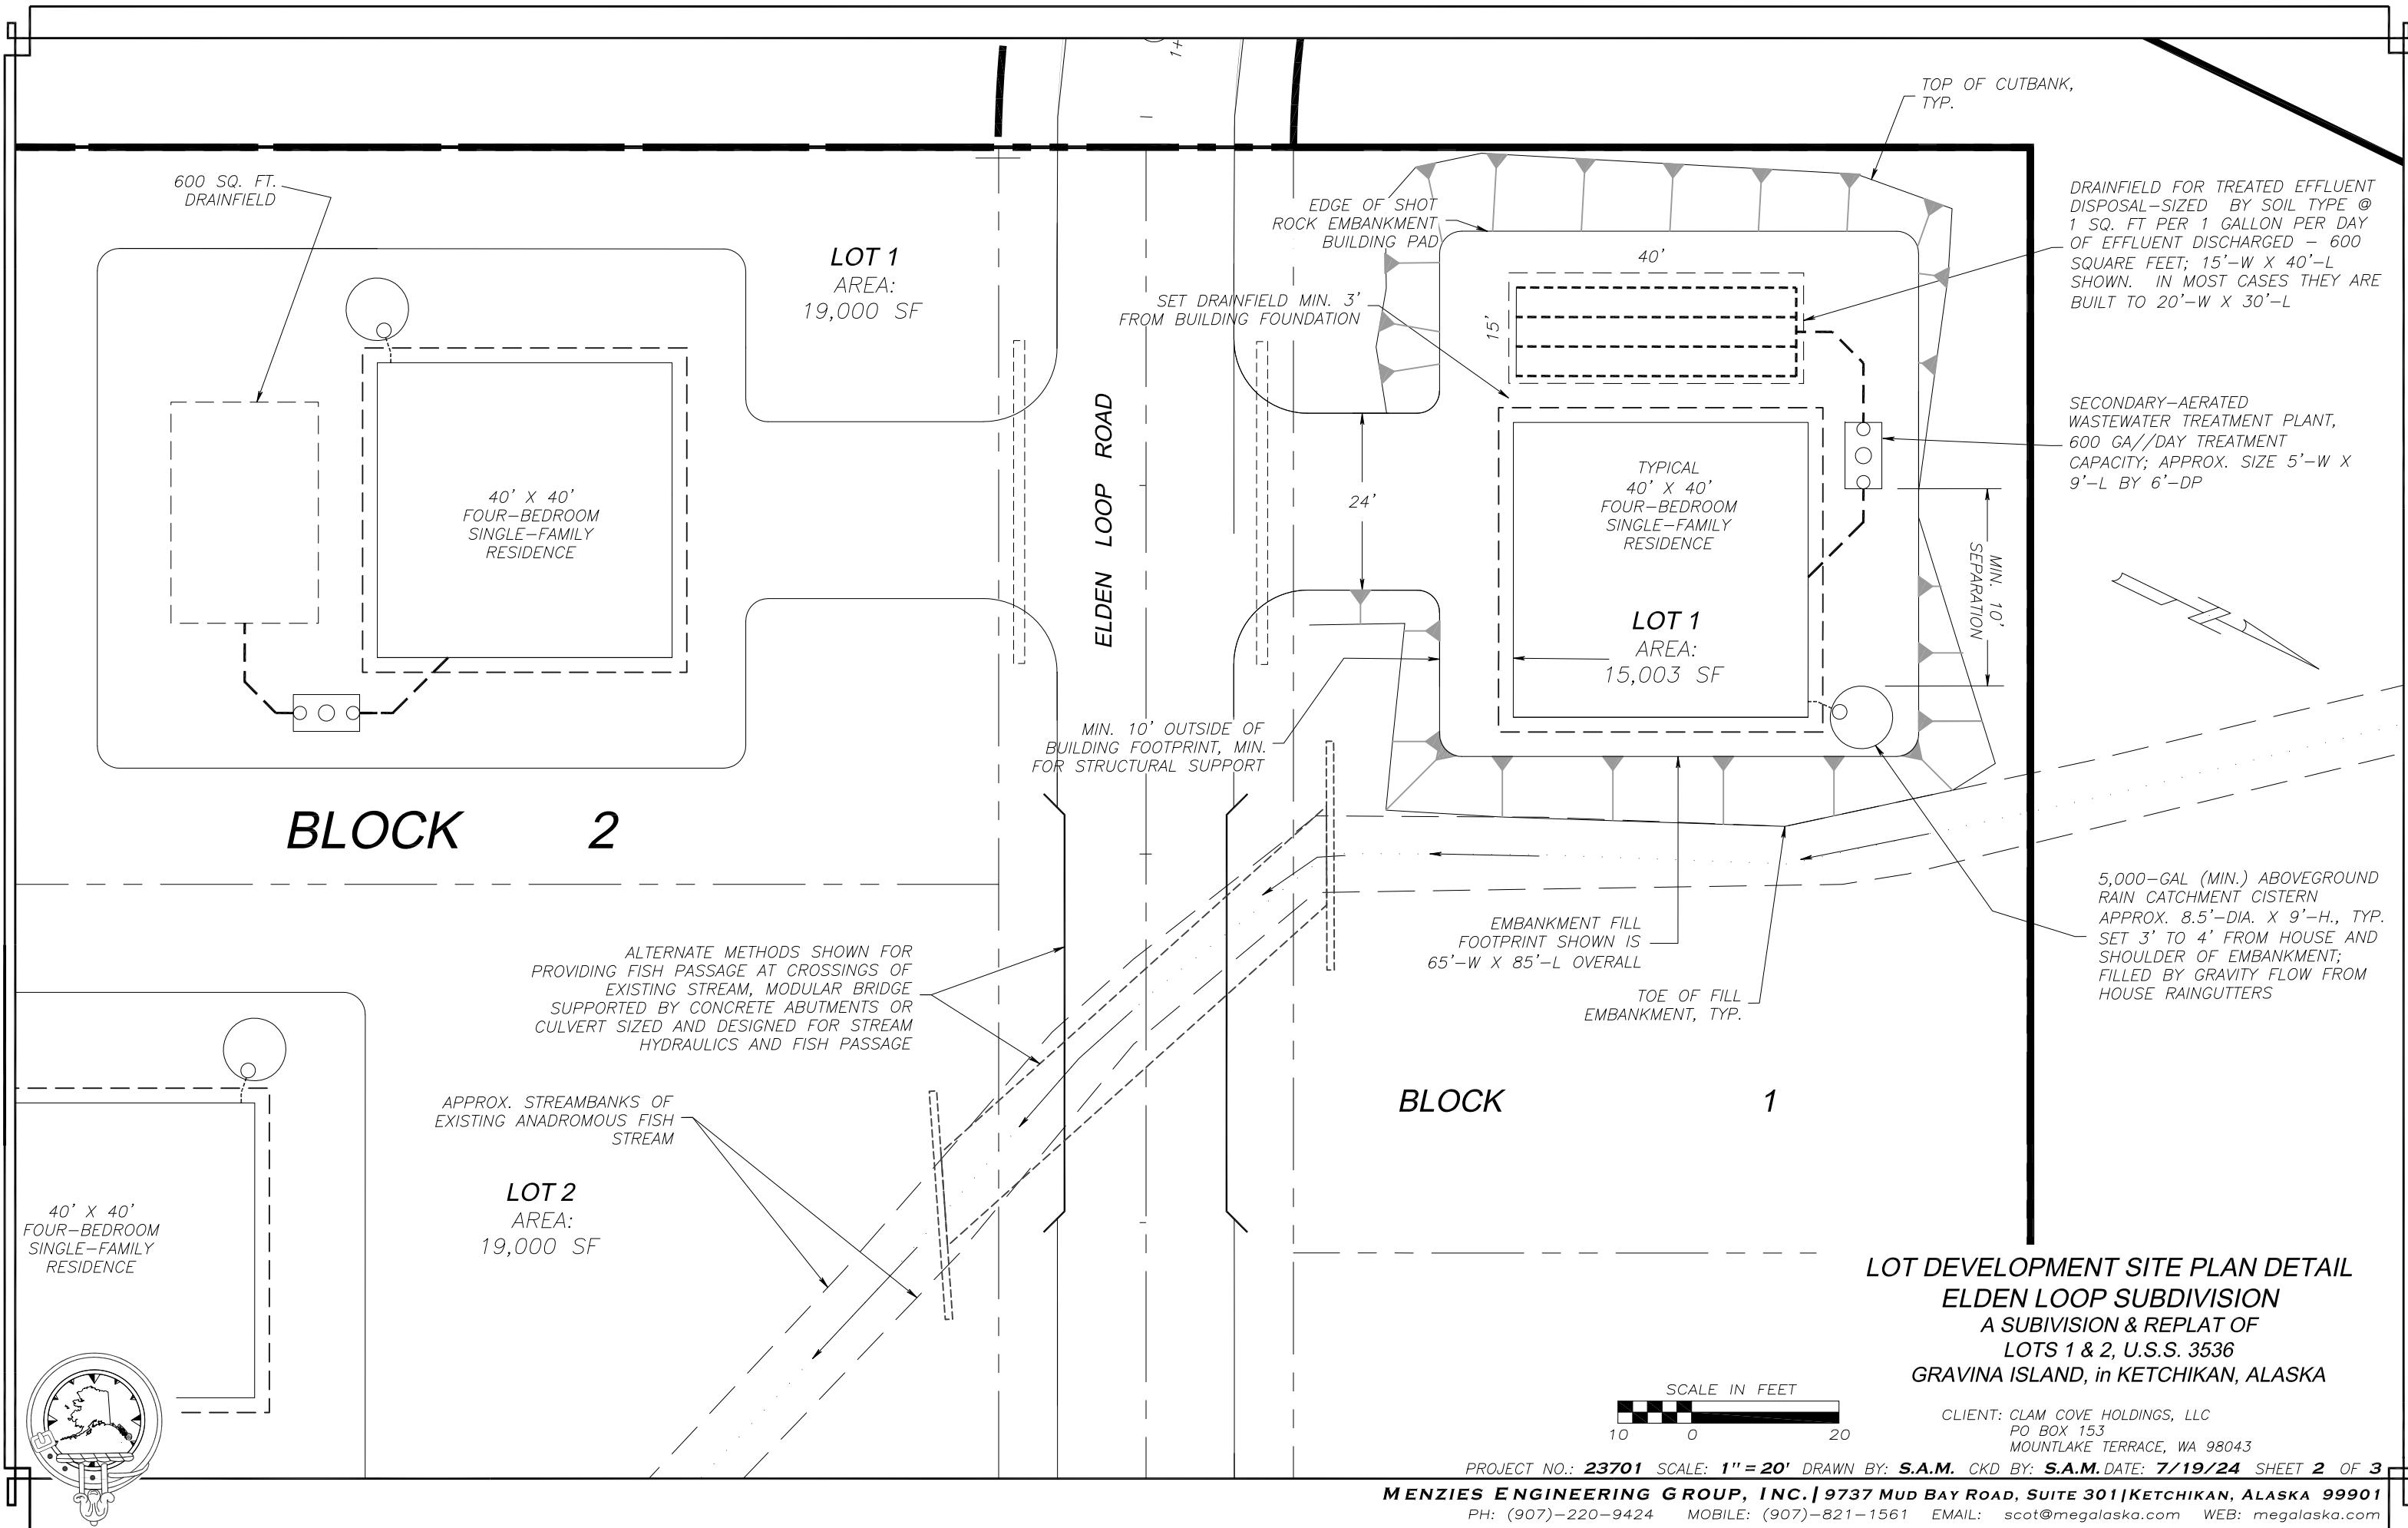

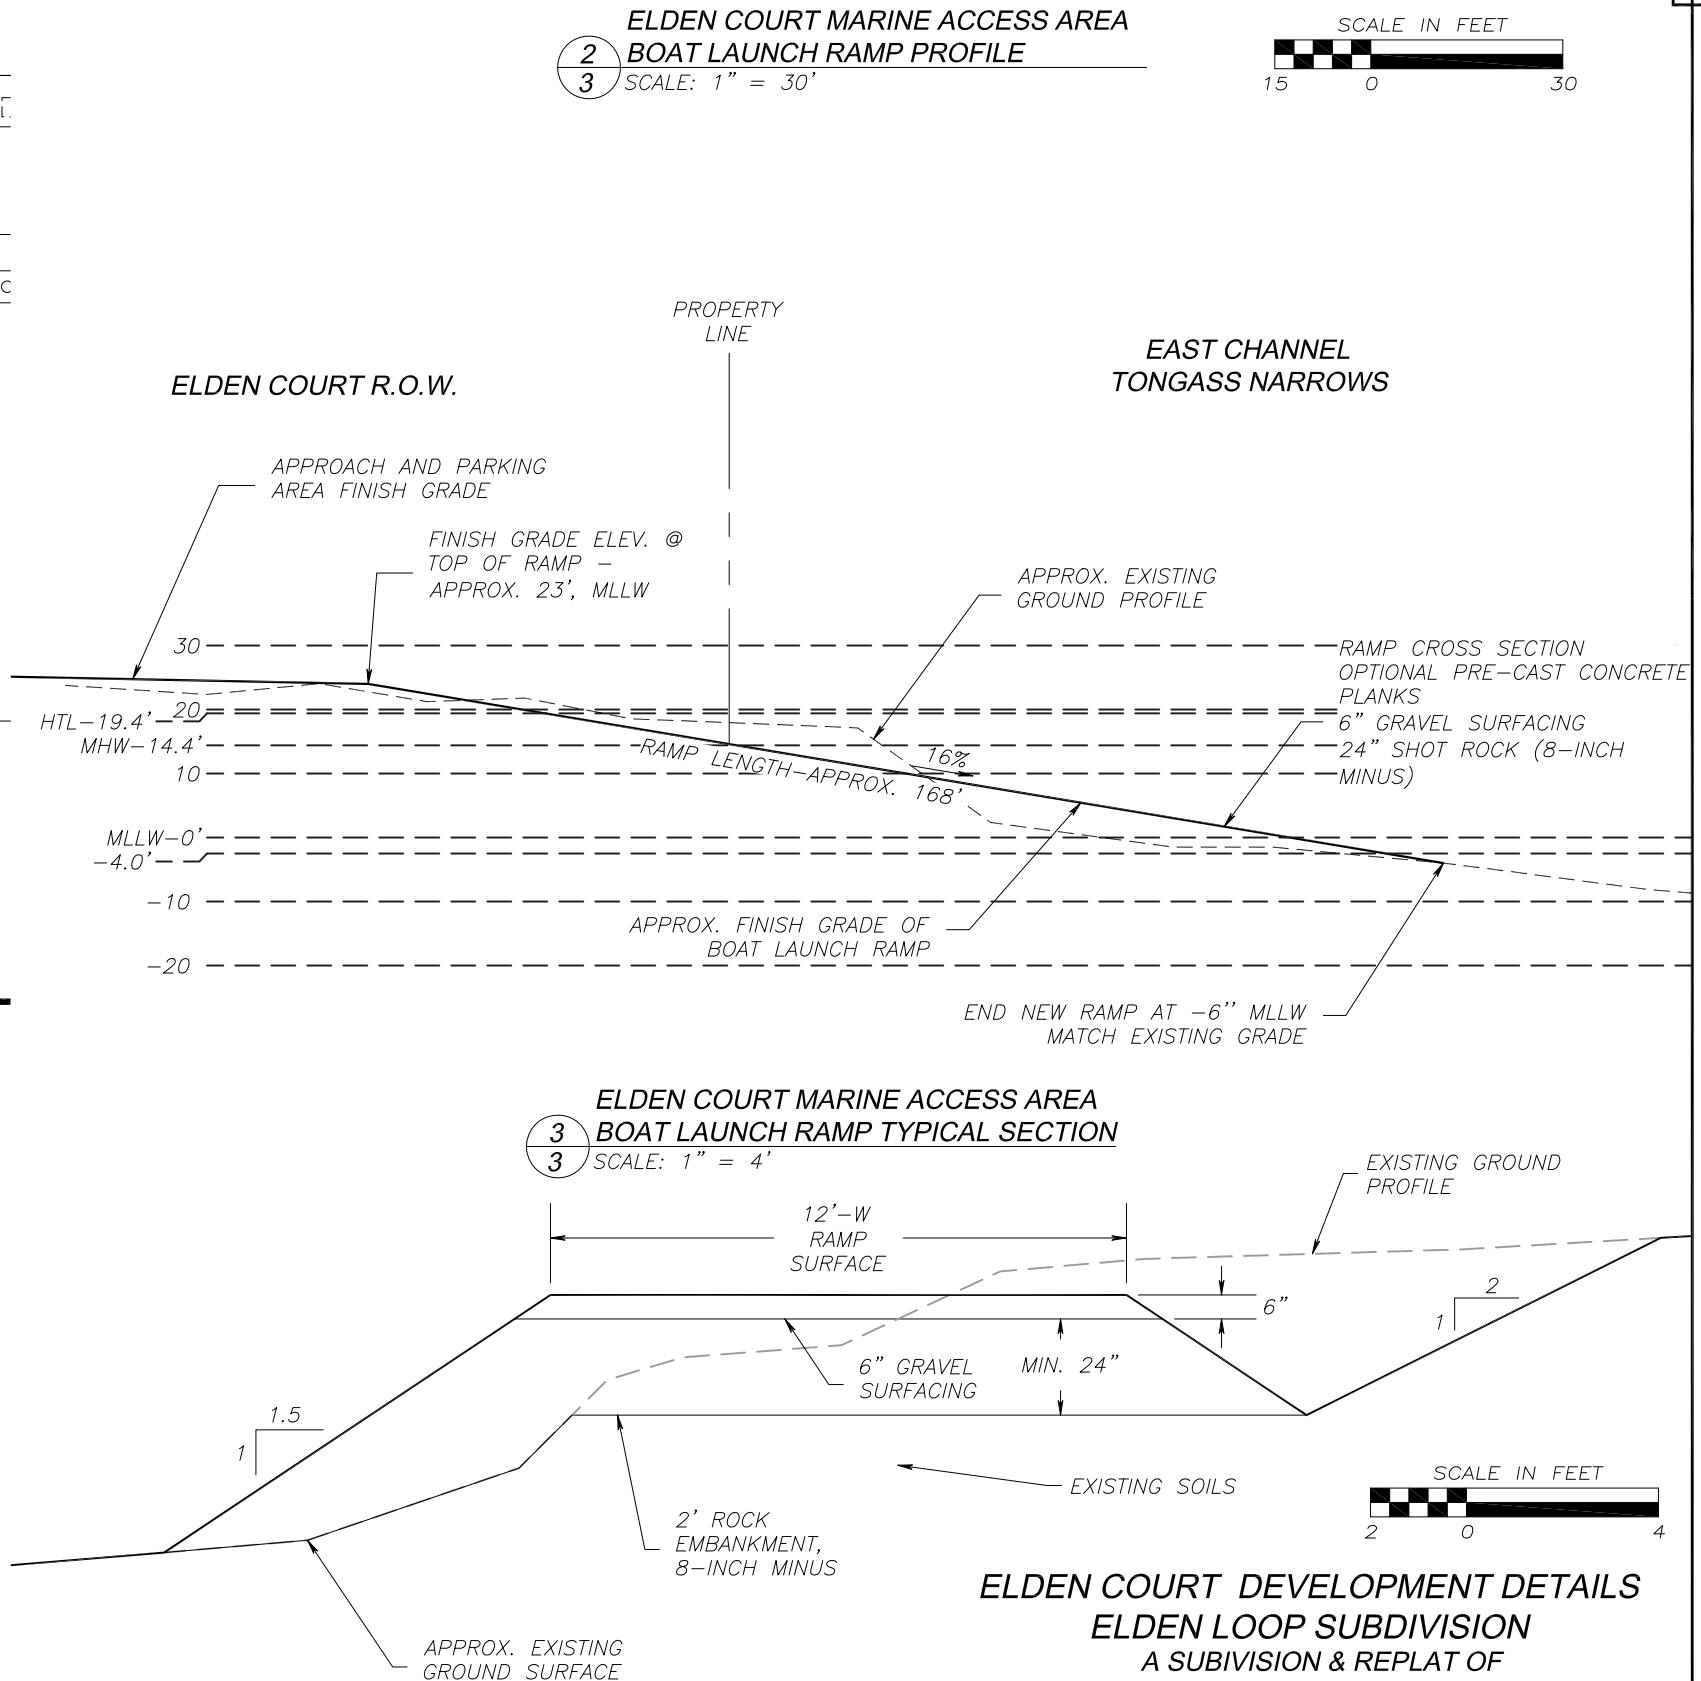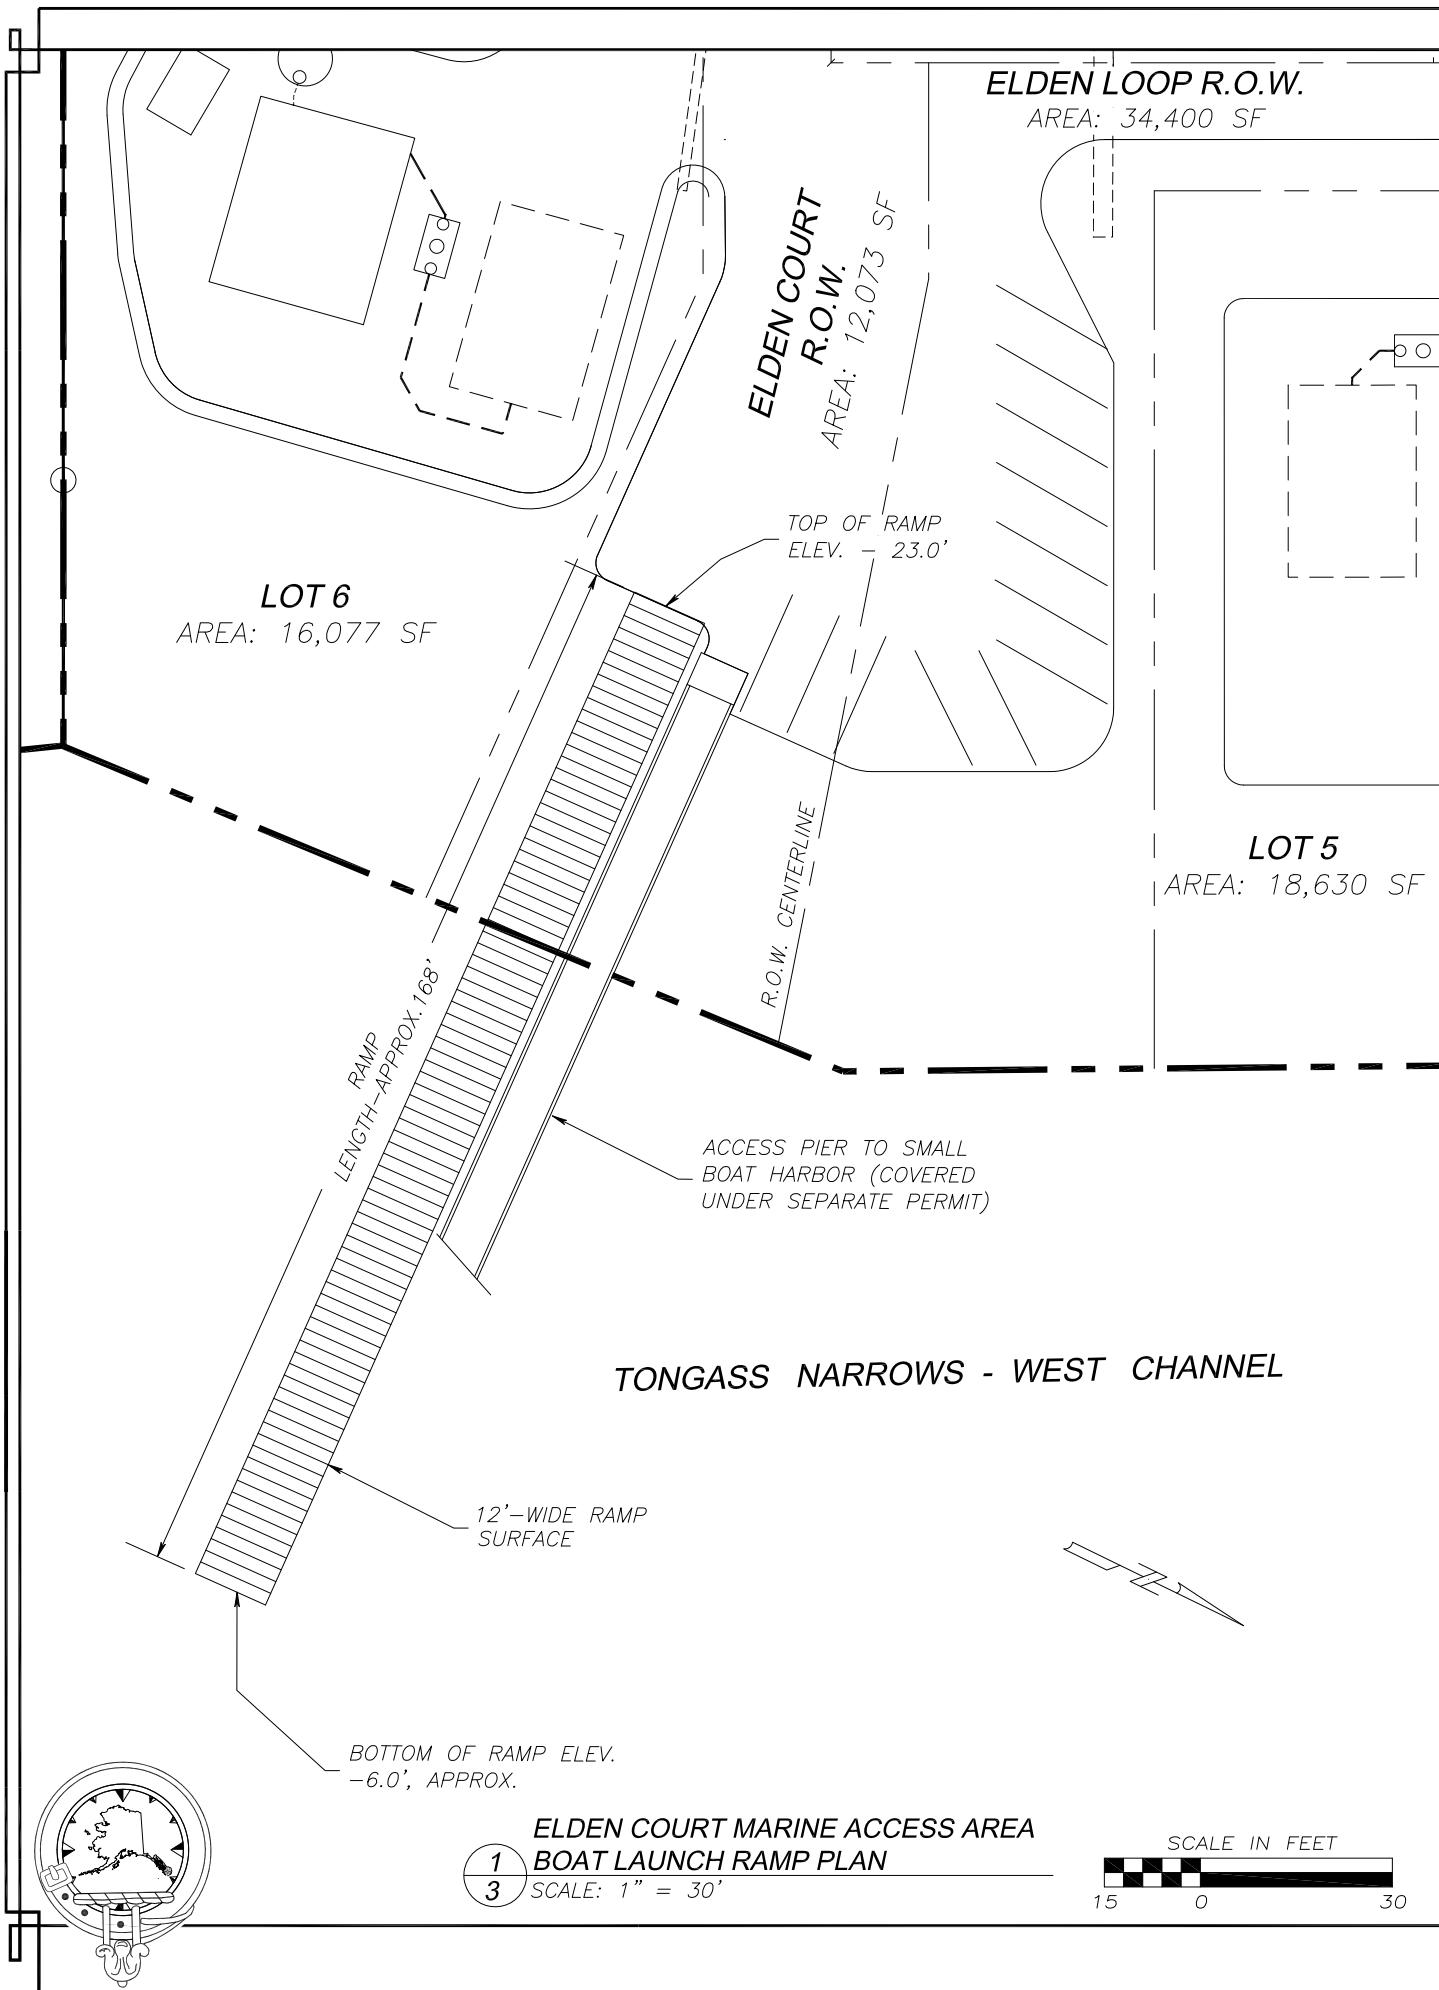

**ELDEN COURT DEVELOPMENT DETAILS  
ELDEN LOOP SUBDIVISION**  
A SUBDIVISION & REPLAT OF  
LOTS 1 & 2, U.S.S. 3536  
GRAVINA ISLAND, in KETCHIKAN, ALASKA

CLIENT: CLAM COVE HOLDINGS, LLC  
PO BOX 153  
MOUNTLAKE TERRACE, WA 98043

PROJECT NO.: 23701 SCALE: AS NOTED DRAWN BY: S.A.M. CKD BY: S.A.M. DATE: 7/19/24 SHEET 3 OF 3

MENZIES ENGINEERING GROUP, INC. | 9737 MUD BAY ROAD, SUITE 301 | KETCHIKAN, ALASKA 99901  
PH: (907)-220-9424 MOBILE: (907)-821-1561 EMAIL: scot@megalaska.com WEB: megalaska.com


POA-2024-00092 Sheet 17 of 21  
February 24, 2025

DESIGN DEVELOPMENT DRAWING

PROPOSED BOAT LAUNCH RAMP AND FLOATS OVERVIEW

SCALE 1"=50'

ENGINEERS LIABILITY LIMITED TO HIS FEE

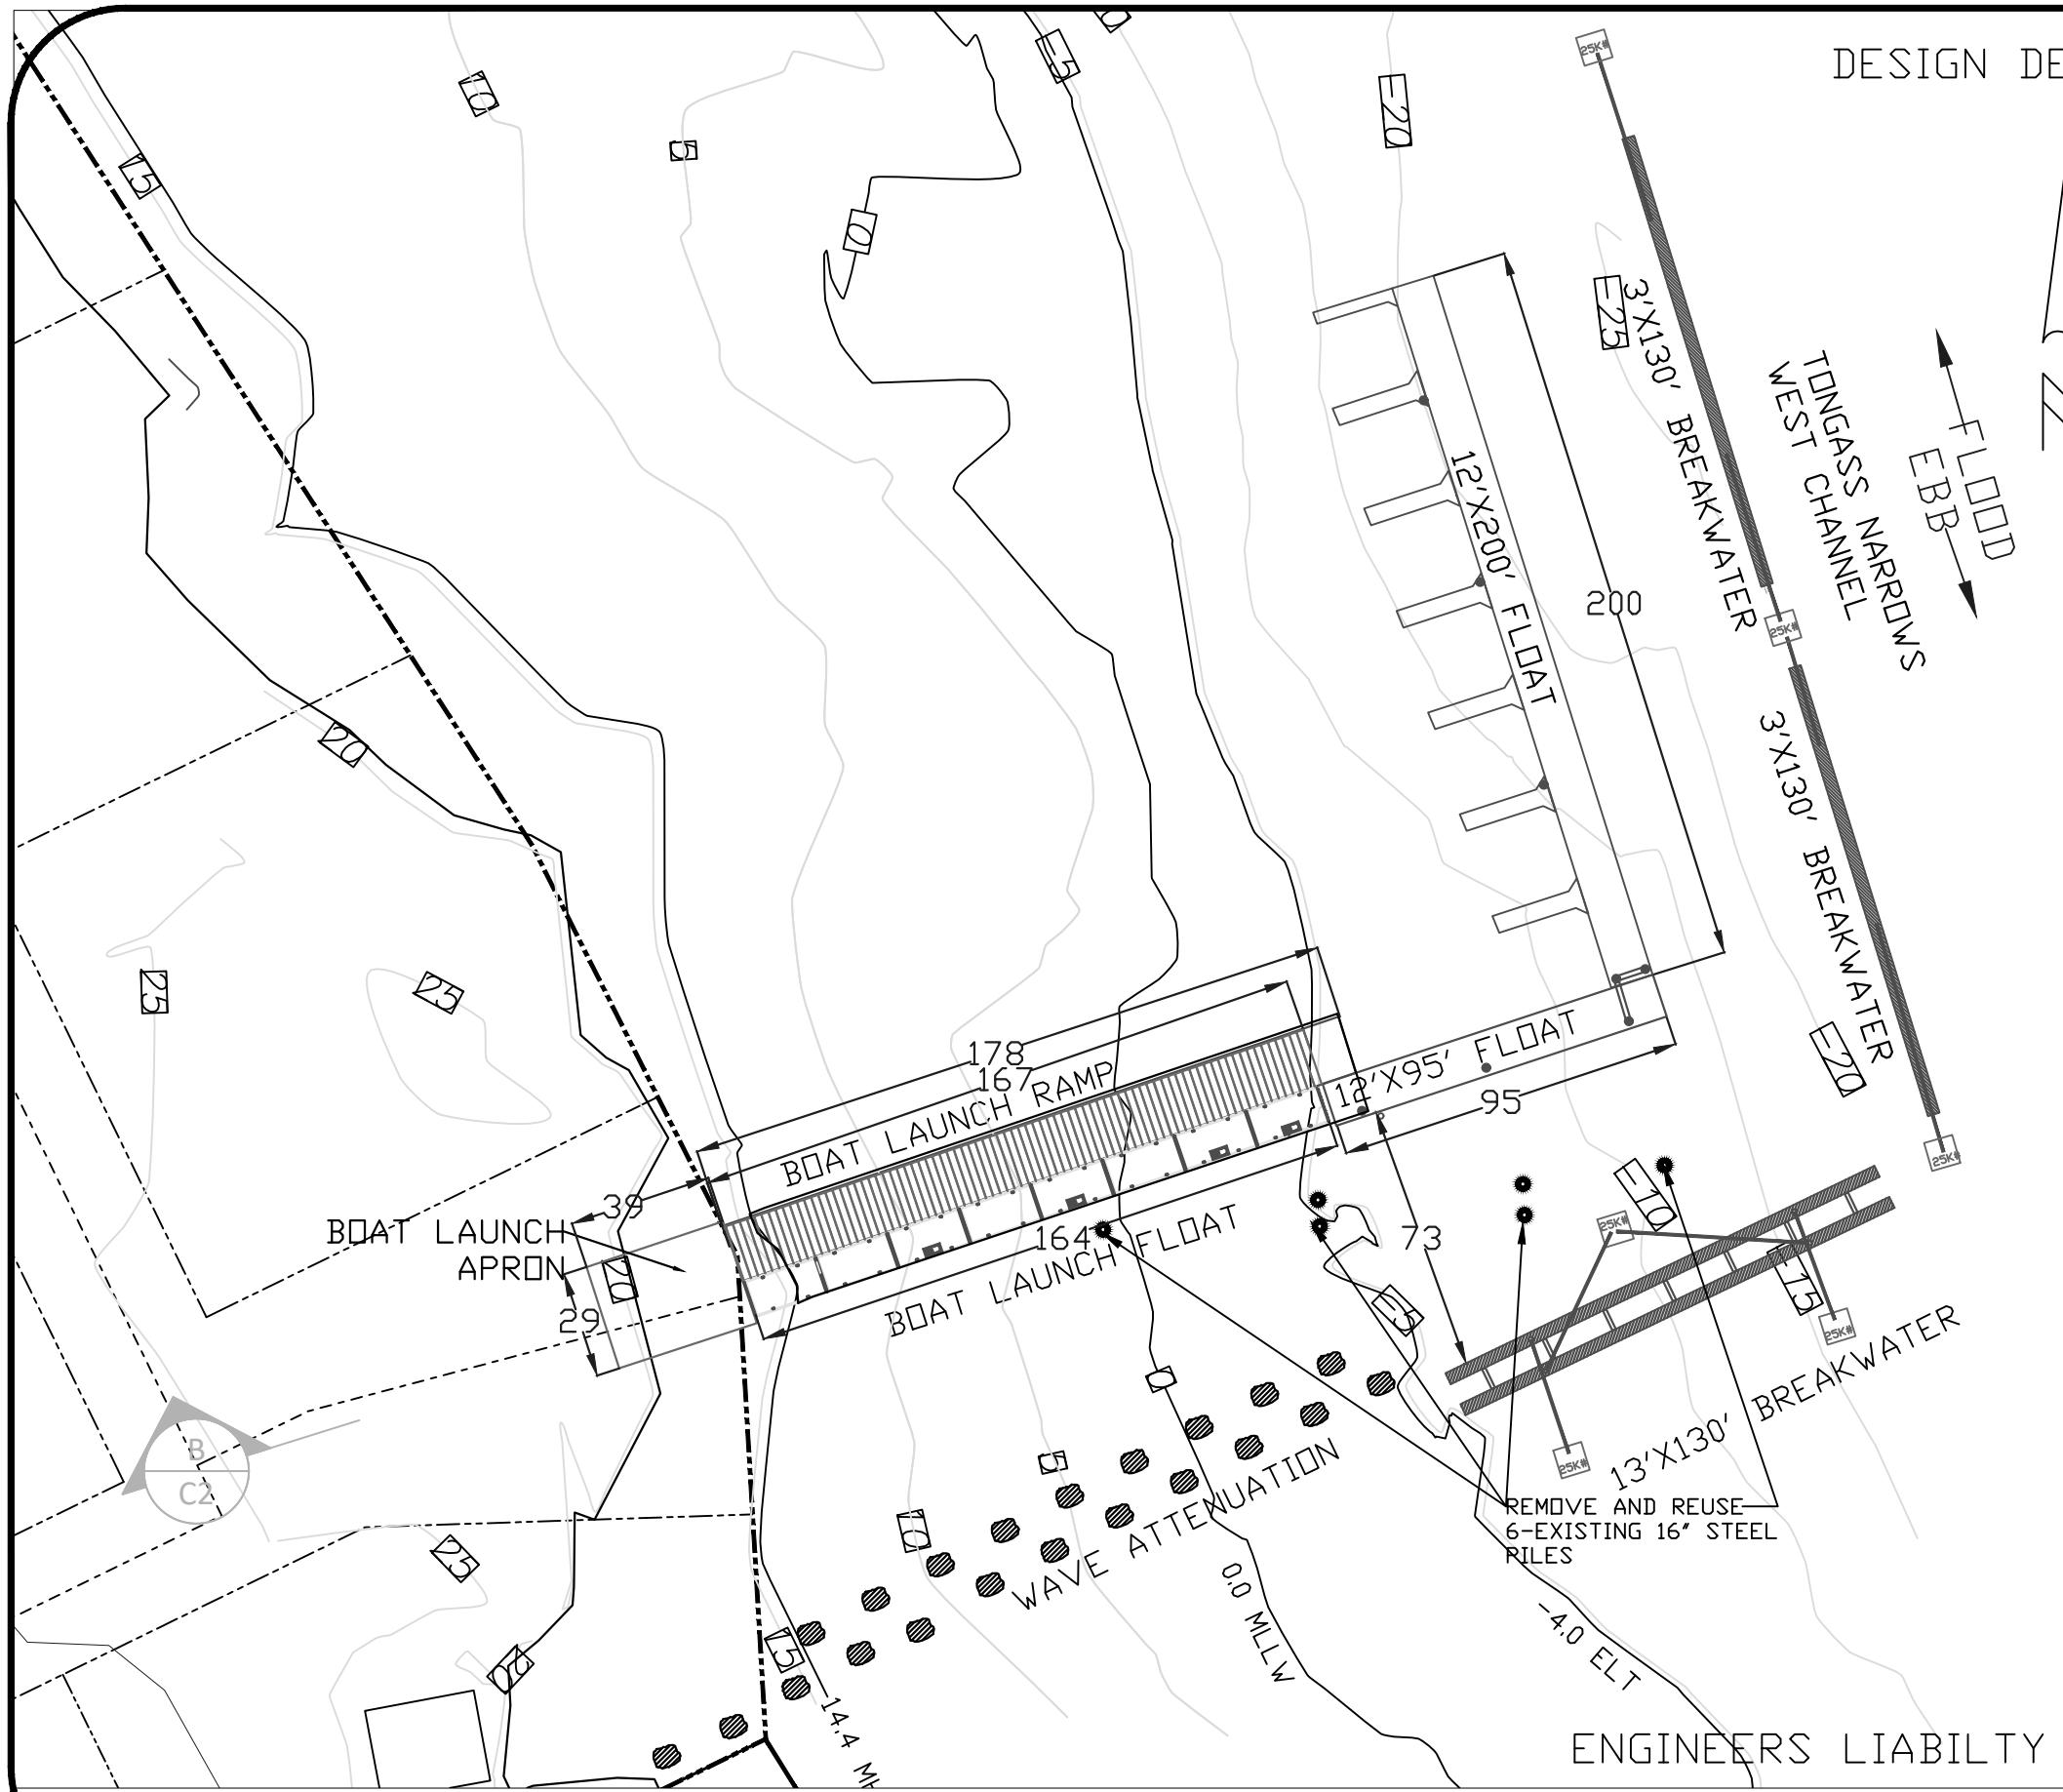

FLOAT & BREAKWATER PLANS  
ELDEN LOOP DEVELOPMENT LLC  
LOT 1 & 2 USS 3536  
LAUNCH RAMP, FLOAT & BREAKWATER PLAN

NO.	REVISION / ISSUE	DATE
-----	------------------	------

PREPARED BY:  
MONREAN ENGINEERING  
& ASSOCIATES INC.  
PO BOX 9343  
KETCHIKAN, ALASKA 99901  
PHONE 907 247-5920  
CELL 907 254-8640  
fmonrean@kpunet.net

PREPARED FOR:  
JEFFERY MILLER  
WAYNE SHARP  
PO BOX 153  
MOUNTLAKE TERRACE, WA 98043

PROJECT:	C1
DATE:	FEB. 7, 2025
SCALE:	AS SHOWN

POA-2024-00092  
Sheet 18 of 21

February 24, 2025

LAUNCH RAMP, FLOAT & BREAKWATER PLAN

SECTION I & 2 U.S.S. 3536

PREPARED BY:  
MONREAN ENGINEERING  
& ASSOCIATES INC.  
PO BOX 9343  
KETCHIKAN, ALASKA 99901  
PHONE 907 247-5920  
CELL 907 254-8640  
fmonrean@kpnet.net






PREPARED FOR:  
JEFFERY MILLER  
WAYNE SHARP  
PO BOX 153  
MOUNTLAKE TERRACE, WA 98043

PROJECT: C2 / C4  
DATE: FEB. 25, 2025  
SCALE: AS SHOWN

POA-2024-00092


Sheet 19 of 21

February 24, 2025

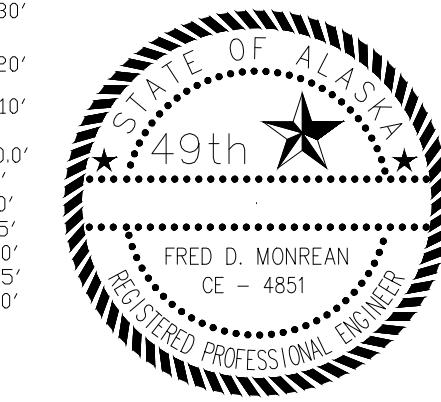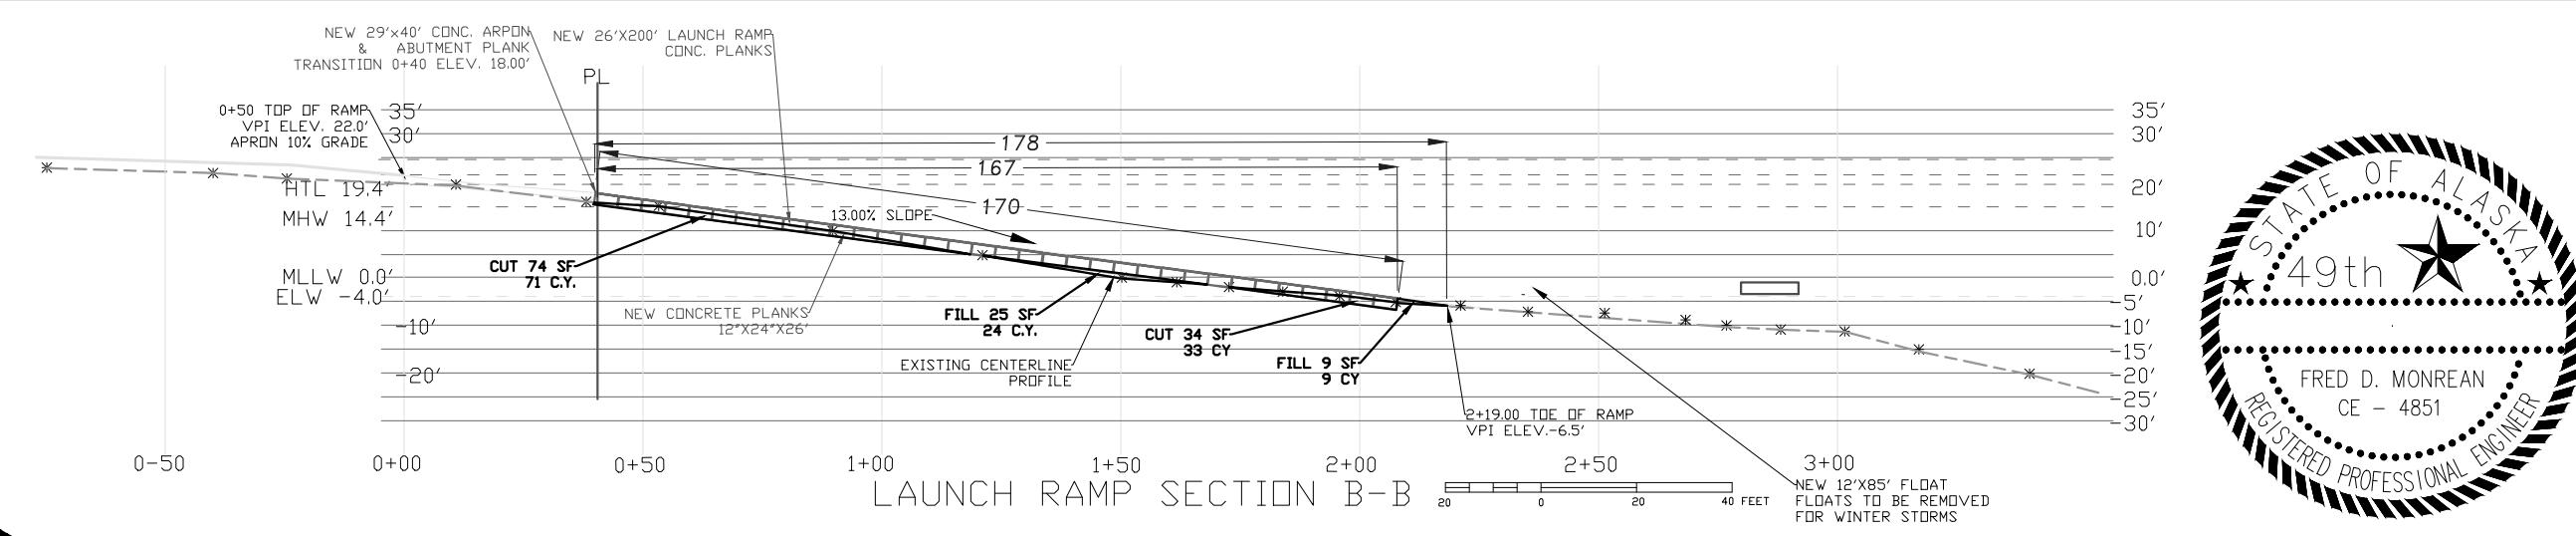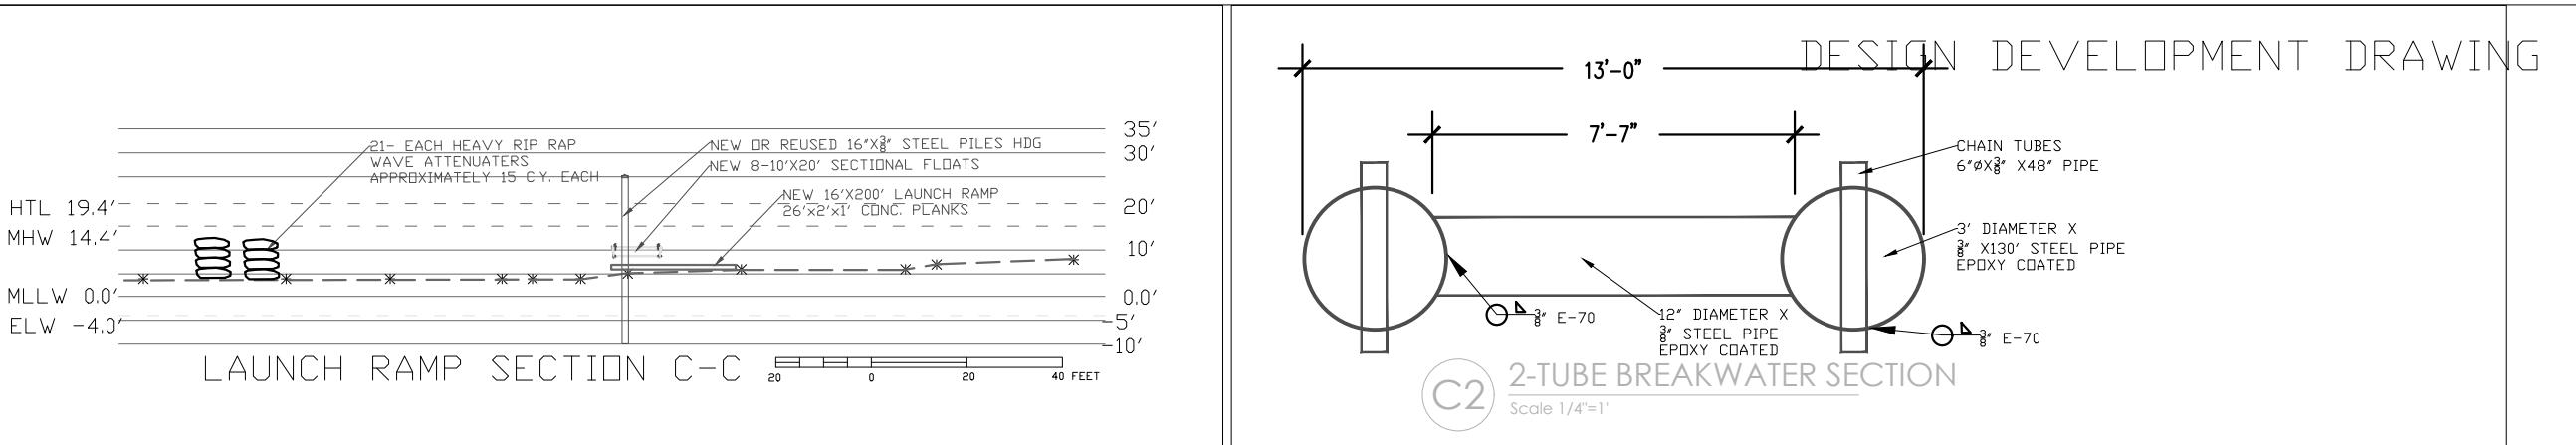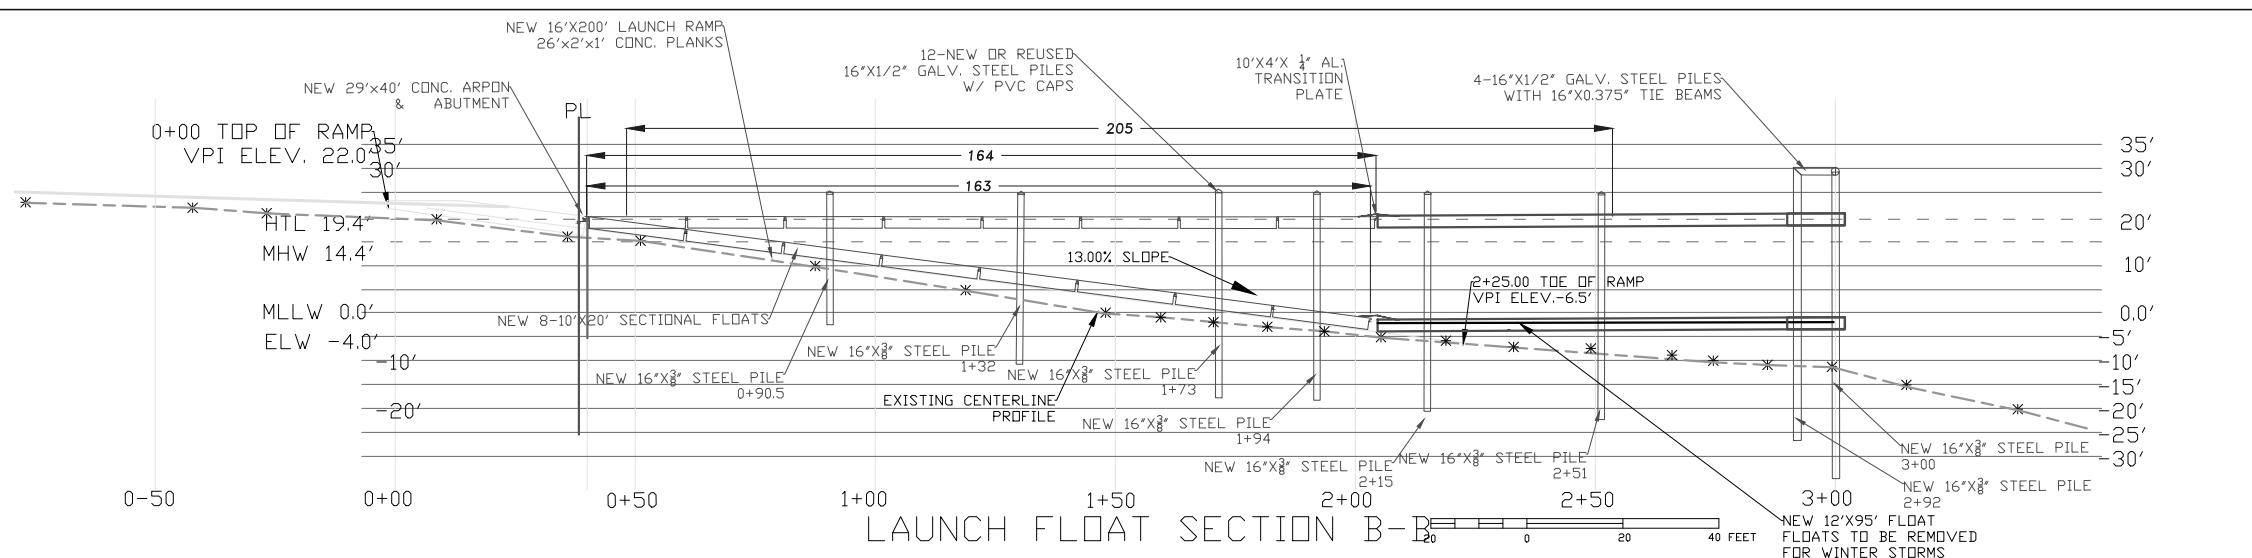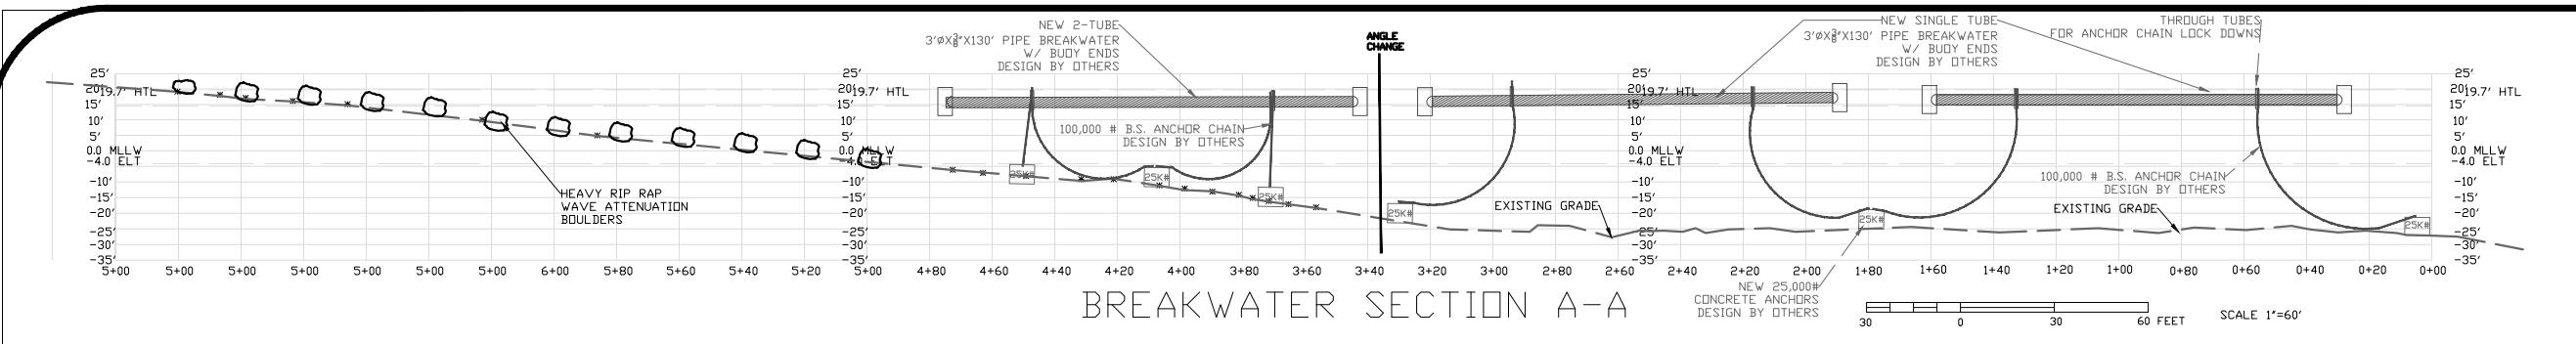

FRED D. MONREAN  
CE - 4851

REGISTERED PROFESSIONAL ENGINEER

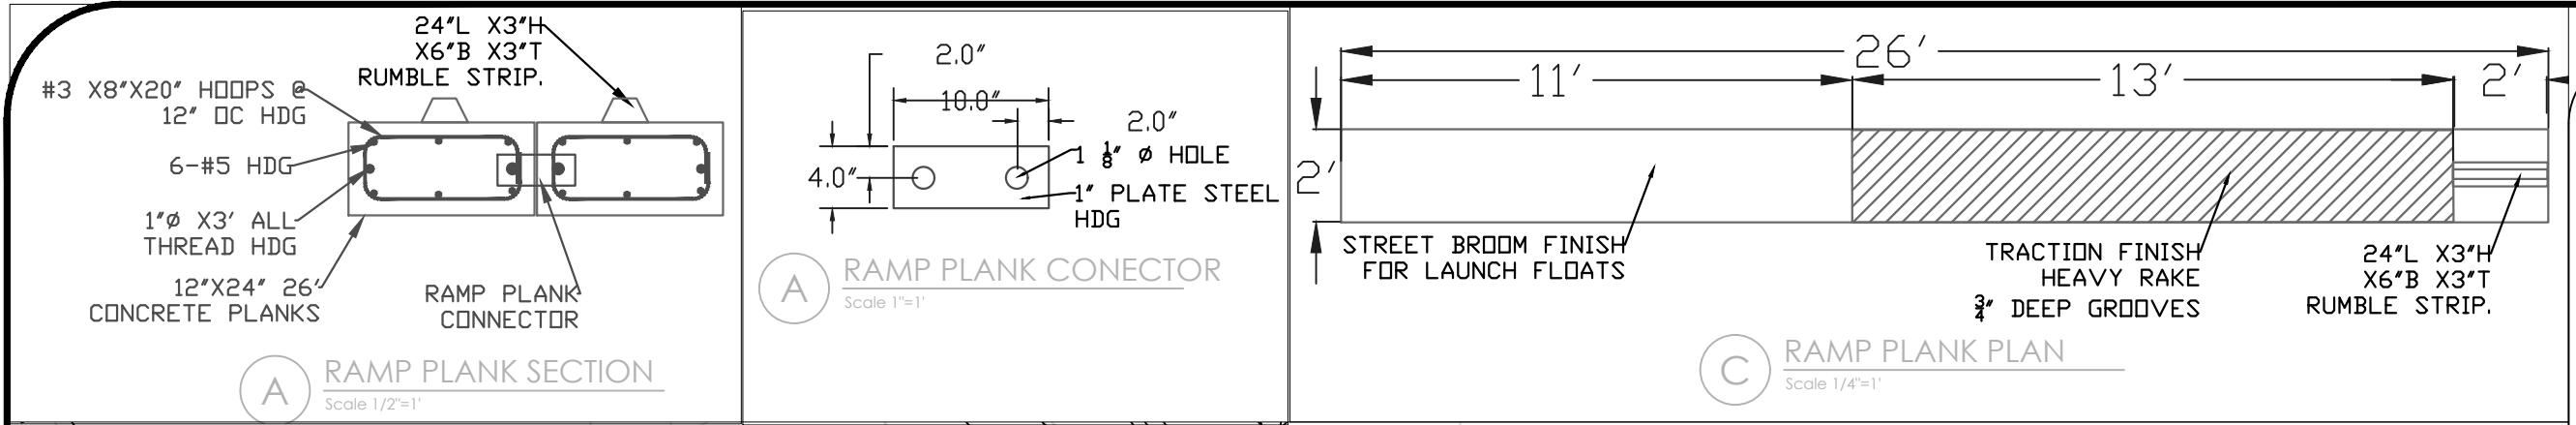


**DETAIL SHEET**  
**ELDEN LOOP DEVELOPMENT LLC**  
**LOT 1 & 2 USS 3536**  
**LAUNCH RAMP, FLOAT & BREAKWATER PLAN**

NO.	REVISION / ISSUE	DATE








**PREPARED BY:**  
MONREAN ENGINEERING  
& ASSOCIATES INC.  
PO BOX. 9343  
KETCHIKAN, ALASKA 99901  
PHONE 907 247-5920  
CELL 907 254-8640  
fmonrean@kpnet.net

**PREPARED FOR:**  
JEFFERY MILLER  
WAYNE SHARP  
PO BOX 153  
MOUNTLAKE TERRACE, WA 98043

**PROJECT:**  
C3  
**DATE:**  
JAN. 15, 2024  
**SCALE:**  
AS SHOWN  
C4

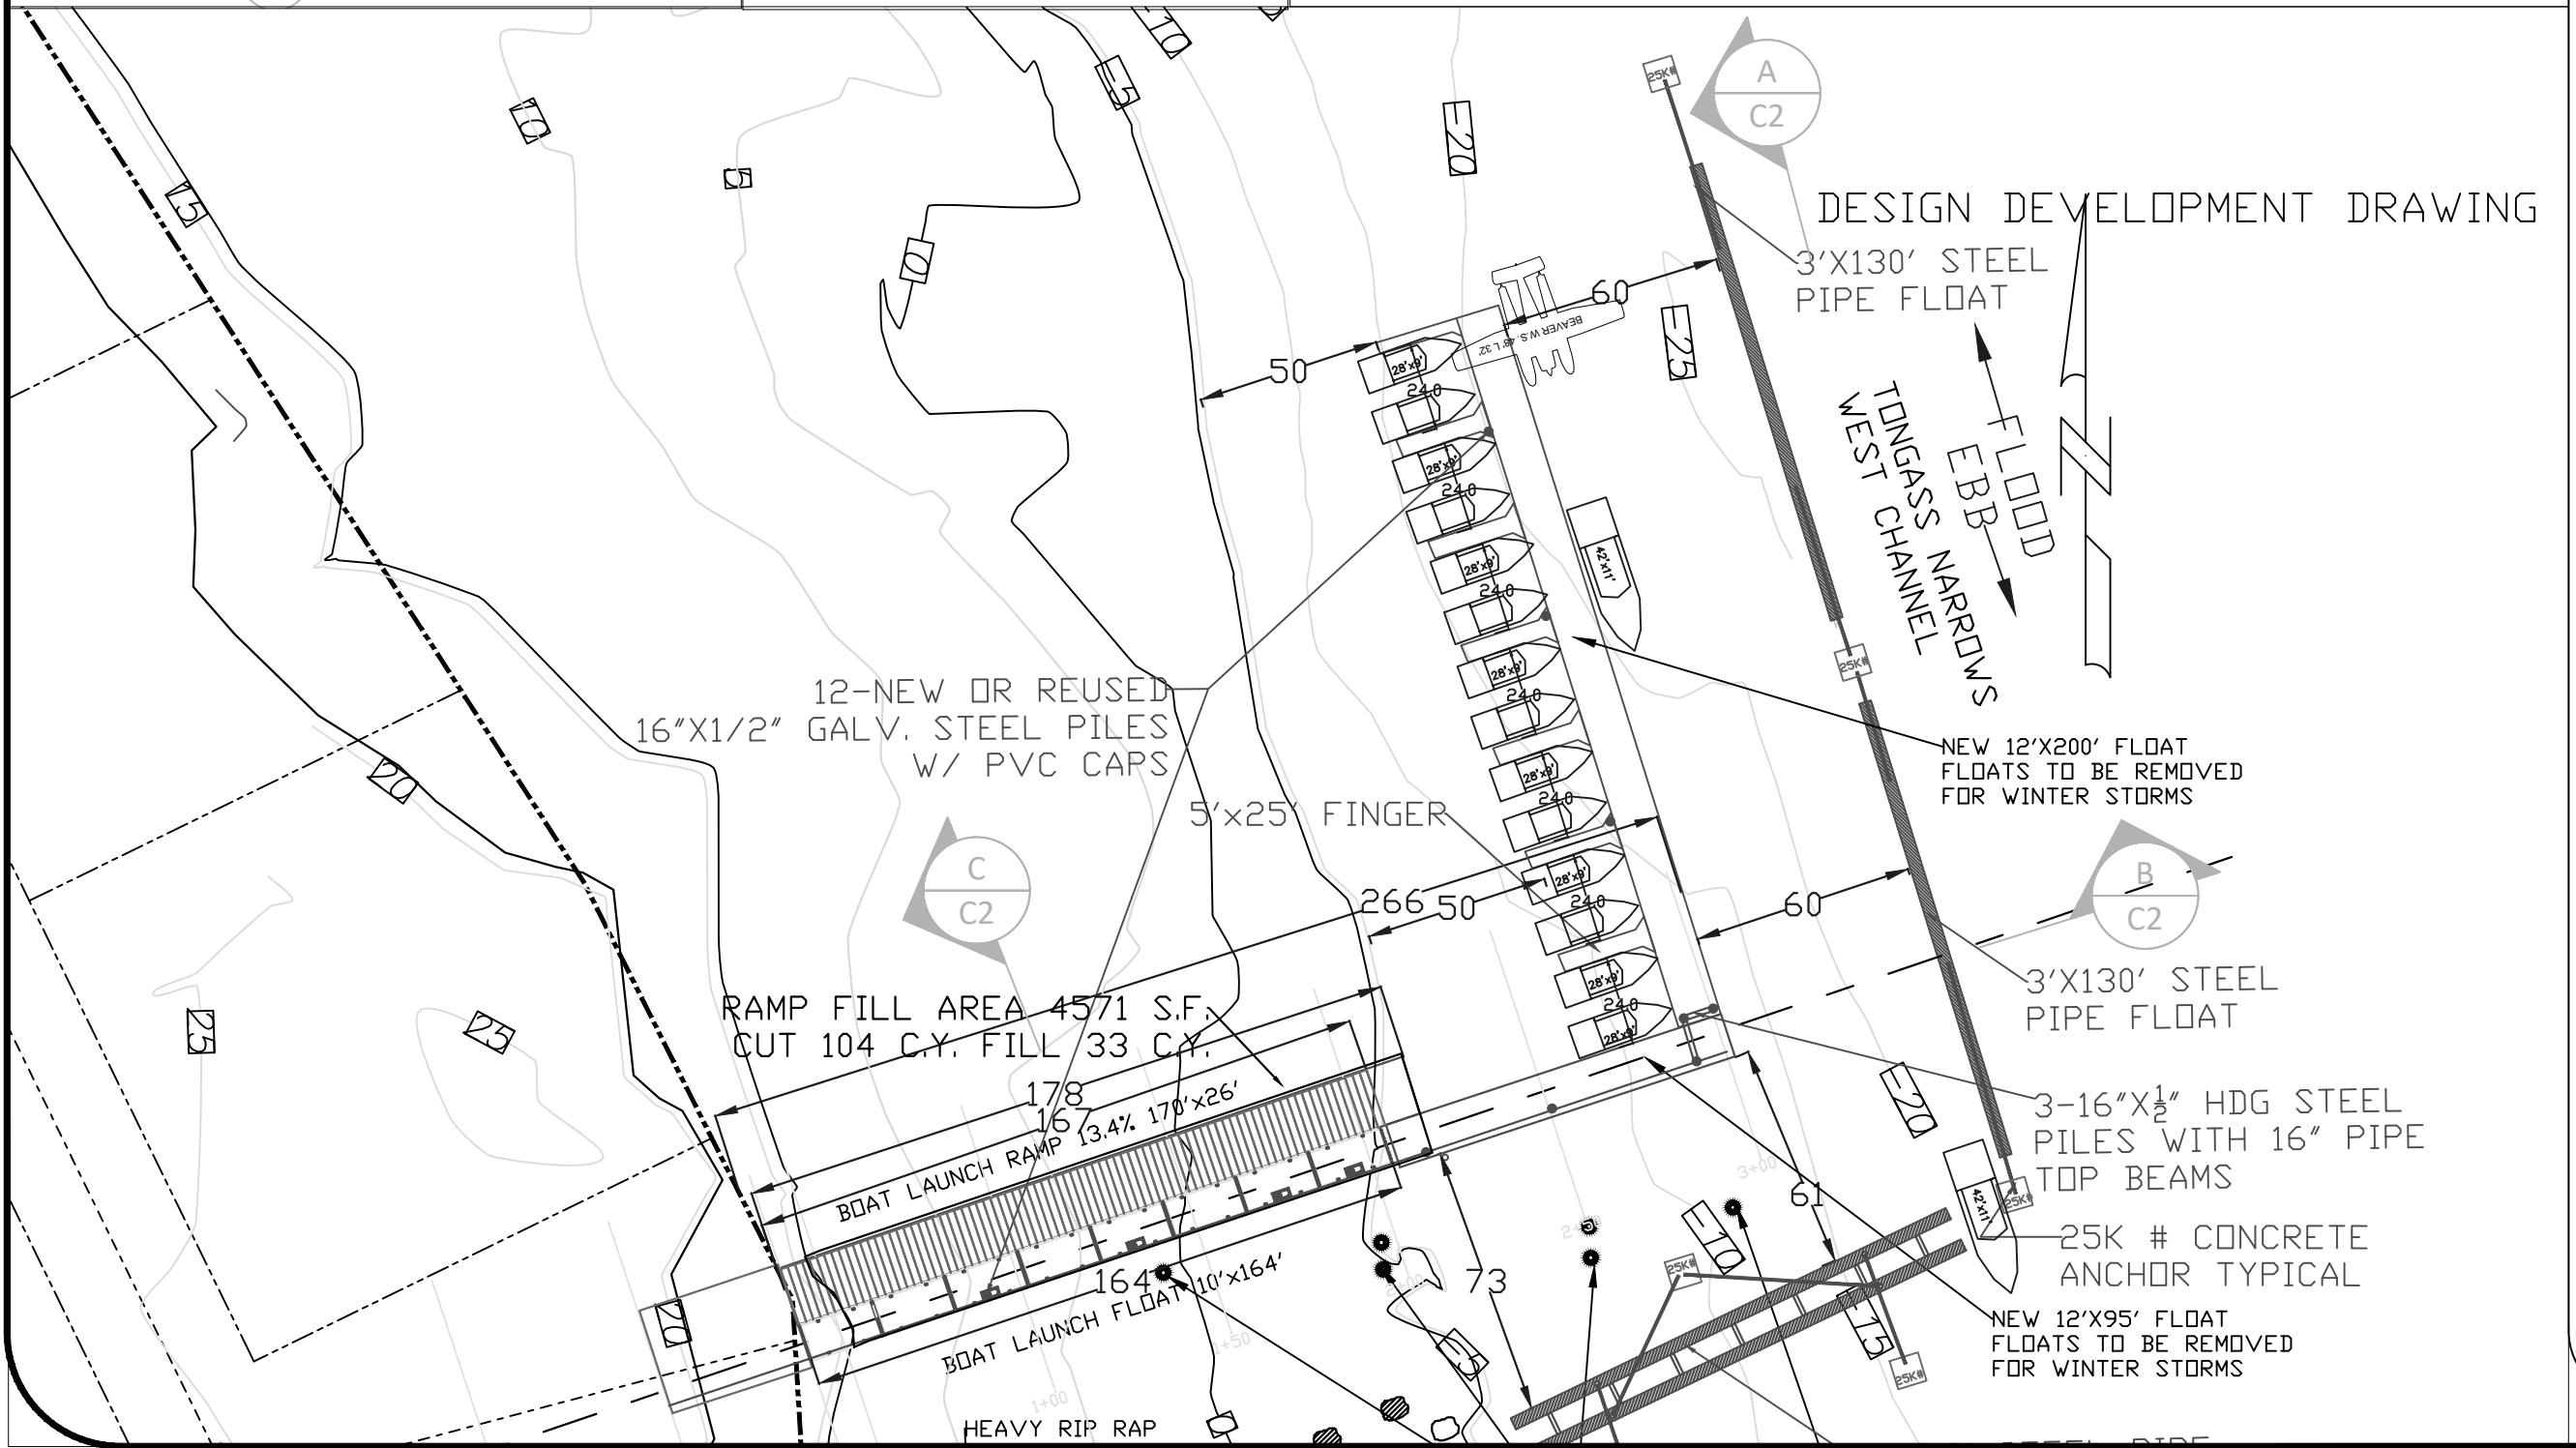

# DESIGN DEVELOPMENT DRAWING

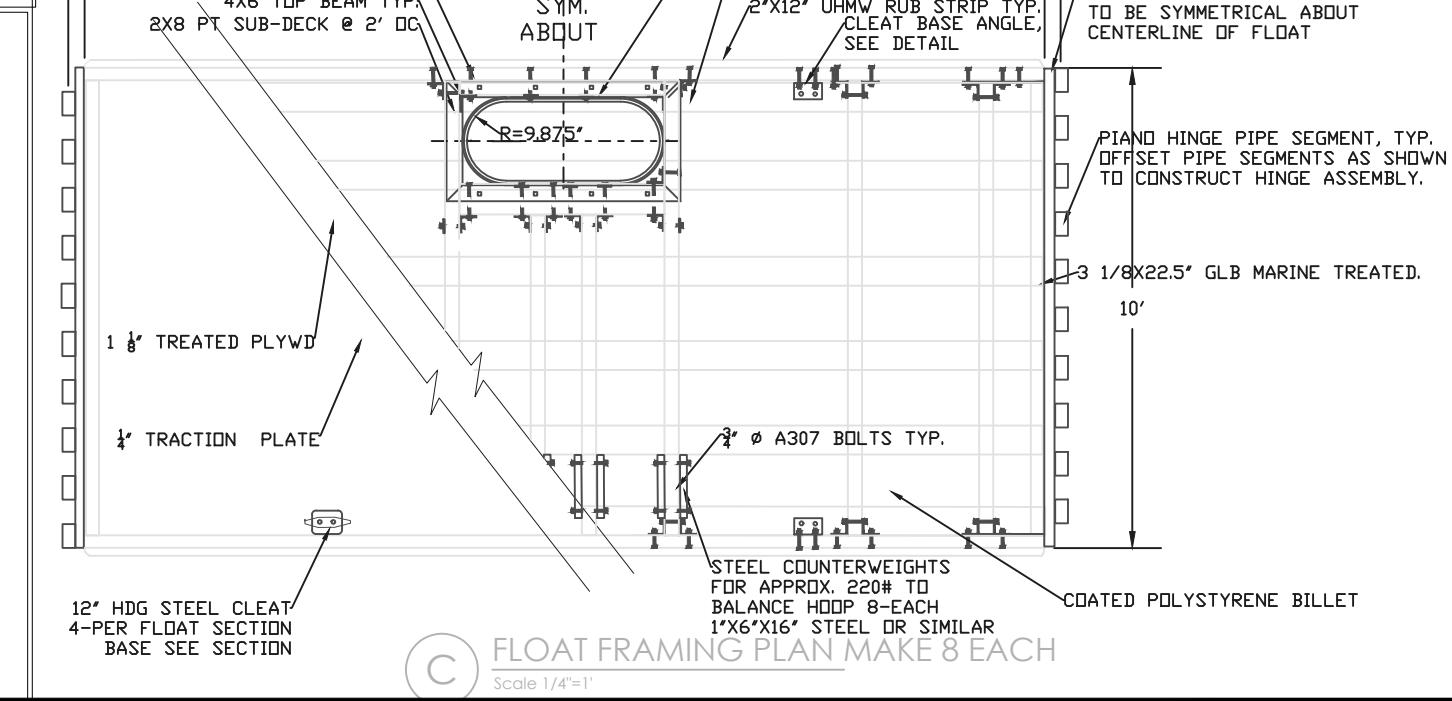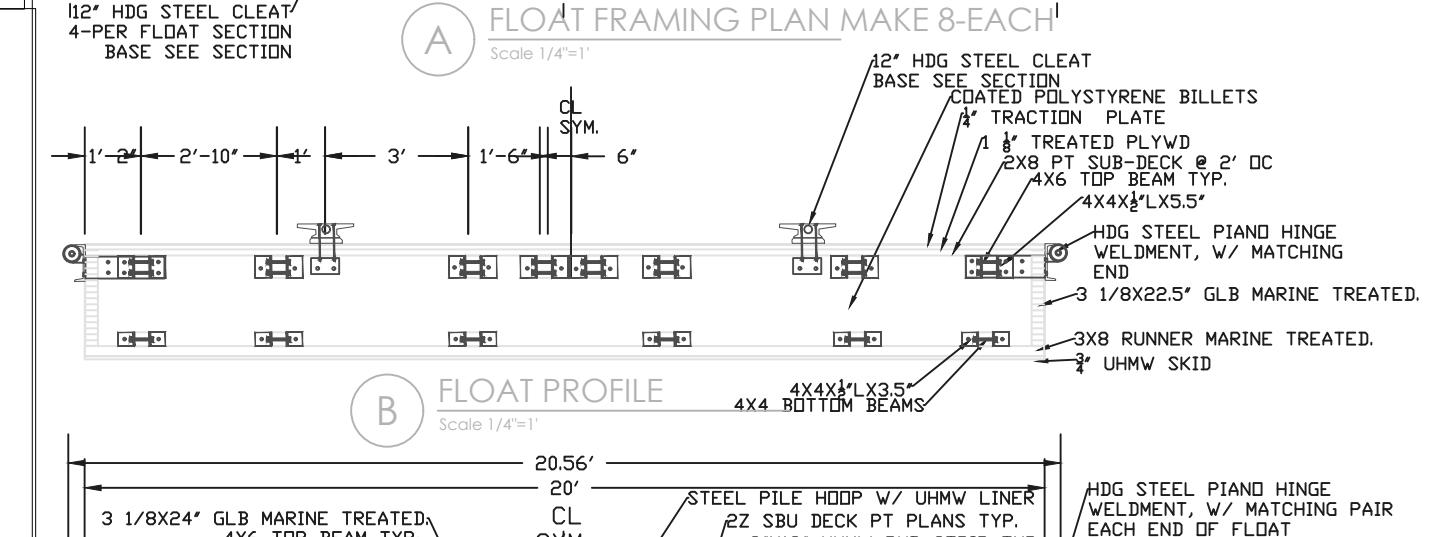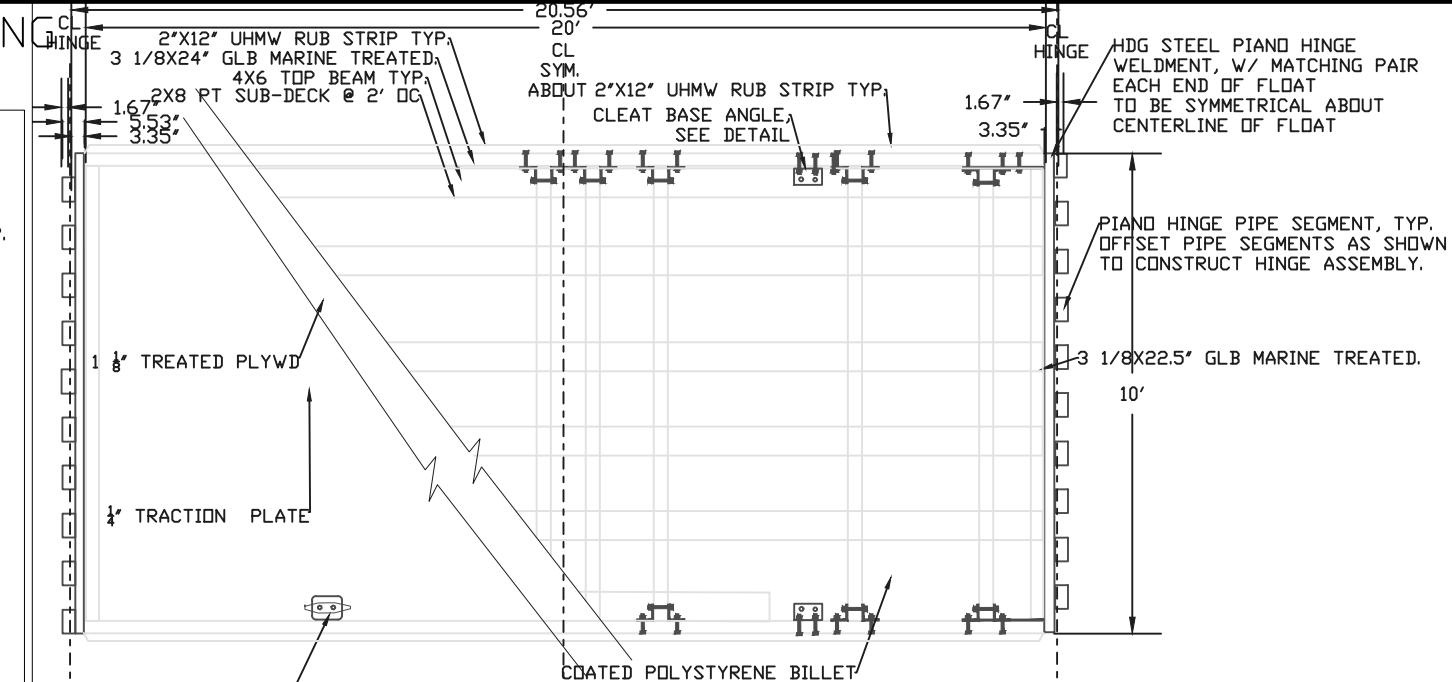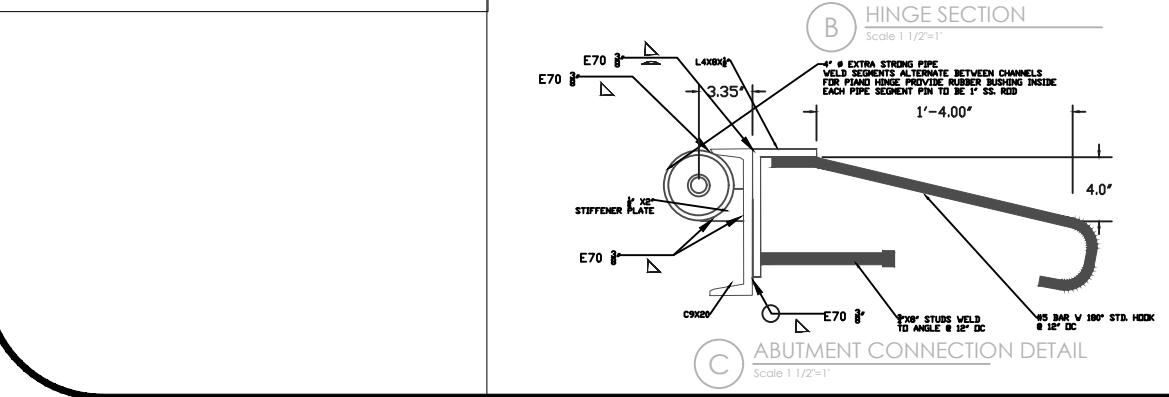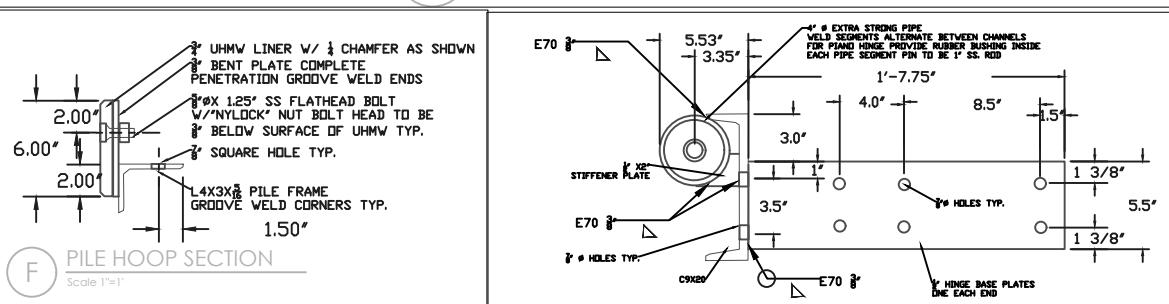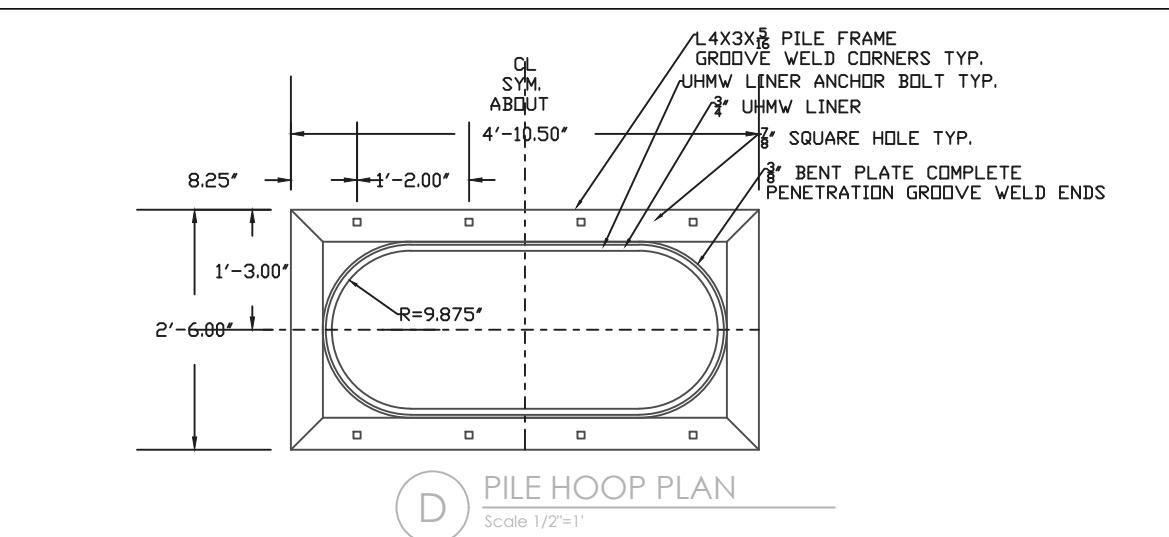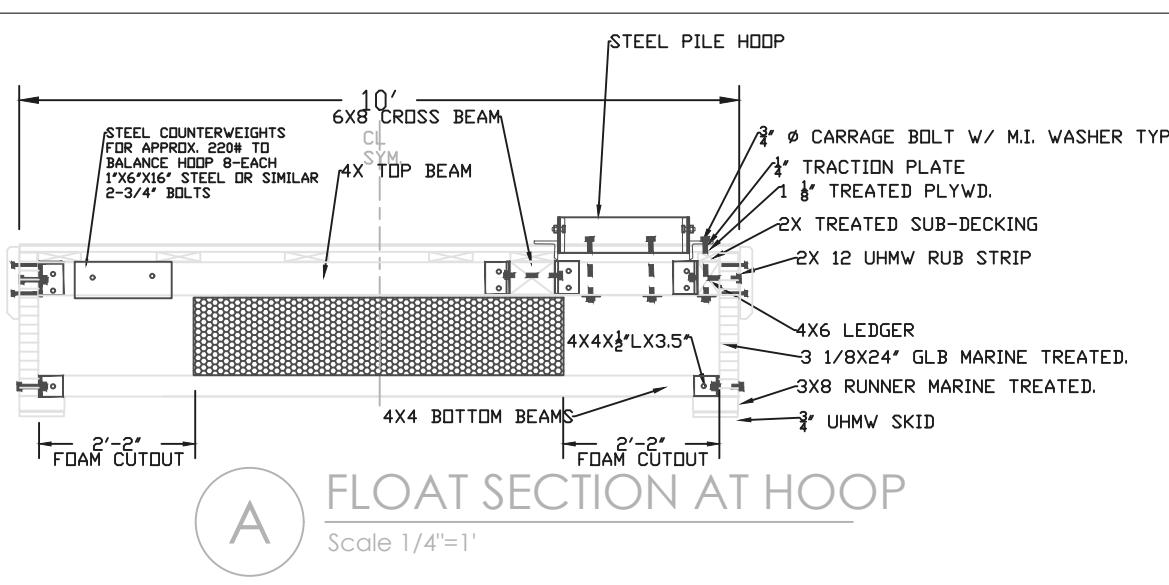

DETAIL SHEET  
ELDEN LOOP DEVELOPMENT LLC  
LOOT 1 & 2 USS 3536  
LAUNCH RAMP, FLOAT & BREAKWATER PLAN

NO.	REVISION / ISSUE	DATE

PREPARED BY:  
MONREAN ENGINEERING & ASSOCIATES INC.  
PO BOX. 9343  
KETCHIKAN, ALASKA 99901  
PHONE 907 247-5920  
CELL 907 254-8640  
fmonrean@kpunet.net

PREPARED FOR:  
JEFFERY MILLER  
WAYNE SHARP  
PO BOX 153  
MOUNTLAKE TERRACE, WA 98043

PROJECT:  
C4  
DATE:  
JAN. 15, 2024  
SCALE:  
AS SHOWN  
C4  
C4